


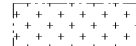


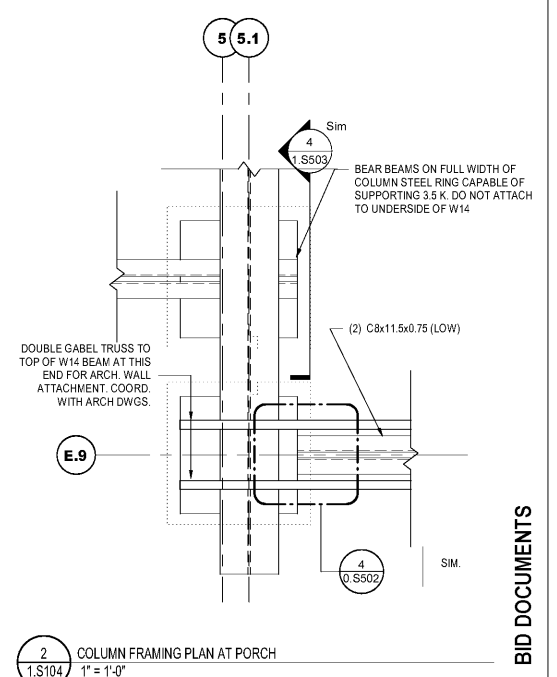
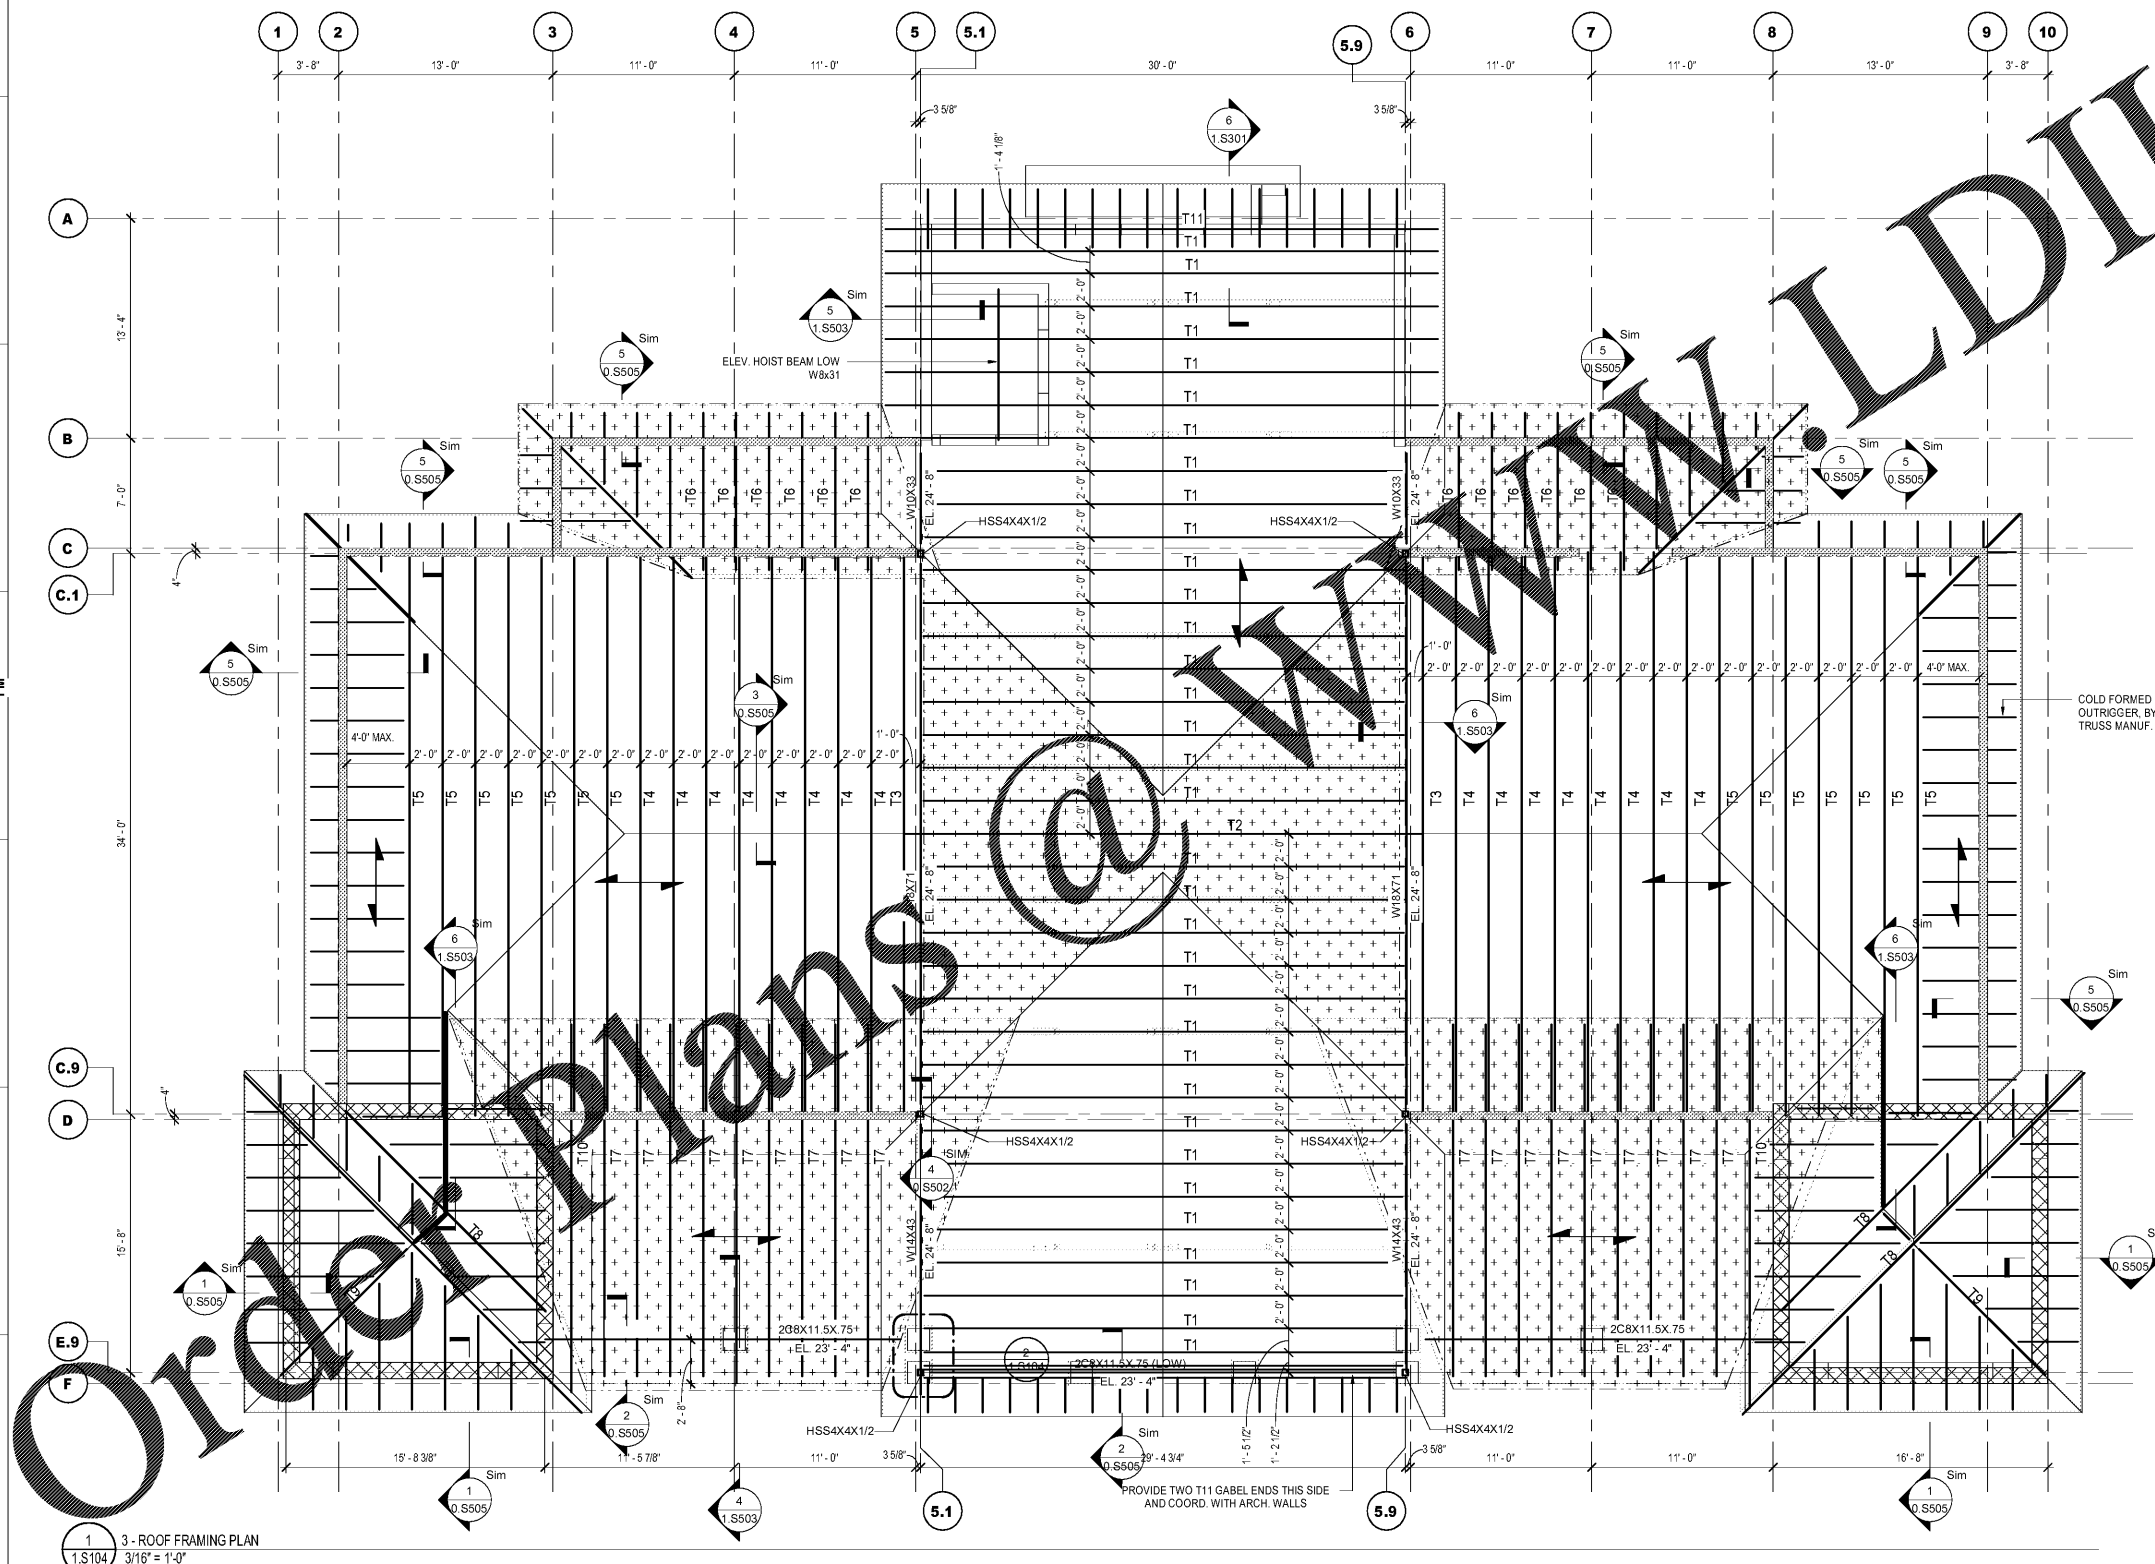
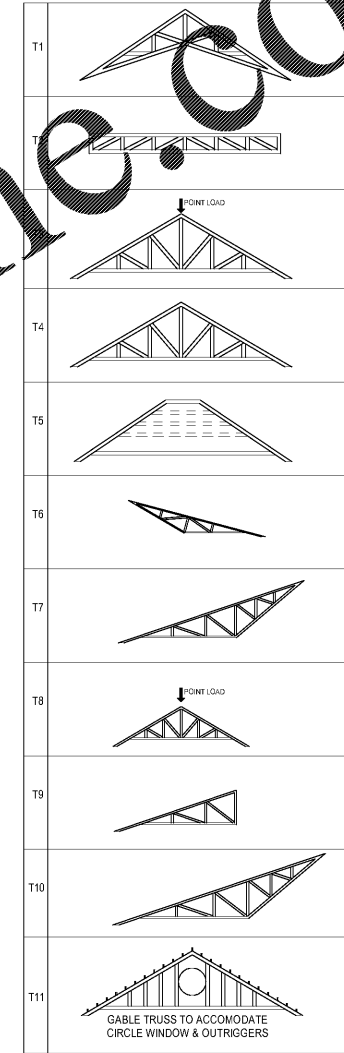
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ROOF FRAMING PLAN NOTES

-  INDICATES ROOF OVERFRAMING
 -  INDICATES LOAD BEARING COLD FORMED STUD WALL.
 -  INDICATES LOAD BEARING CMU WALL.
 -  INDICATES THE DIRECTION THE DECK IS SPANNING.
 - (H): INDICATES HIGH BEAM.
 - (L): INDICATES LOW BEAM.
 - T/S: INDICATES TOP OF STEEL BEAM REFERENCED FROM ELEVATION [0'-0"]
- NOTE 1: ROOF DECK TO BE 1 1/2" TYPE B 22 GAUGE
- NOTE 2: TRUSS BEARING ELEVATIONS TO BE DETERMINED BY ARCHITECT AND TRUSS DESIGNER. TYP. SEE ARCHITECTURAL SHEETS 1.A201 - 1.A203 AND 1.A301 - 1.A303
- NOTE 3: COORDINATE ROOF OVERHANG WITH TRUSS MANUF.

TRUSS LEGEND

- NOTE 1: TRUSSES DESIGNED TRUSS MANUFACTURER. ATTACH EACH VALLEY TRUSS TO THE COMMON TRUSSES BELOW USING (1) SIMPSON VTC2 VALLEY TRUSS CLIP AT EACH END OF EACH VALLEY TRUSS.
- NOTE 2: TRUSS BEARING ELEVATIONS TO BE DETERMINED BY ARCHITECT AND TRUSS DESIGNER.
- NOTE 3: TRUSS OVERHANG EXTENT TO BE DETERMINED BY ARCHITECT AND TRUSS DESIGNER.



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Revisions		
Rev. No.	Rev. Date	

DRAWN BY: BE
 CHECKED BY: CR
 DATE: 06.01.2018

COAST PROJECT NO. 1722.00

BOAT HOUSE ROOF FRAMING PLAN

1.S104

BID DOCUMENTS

2 COLUMN FRAMING PLAN AT PORCH
 1.S104 1" = 1'-0"

1 3 - ROOF FRAMING PLAN
 1.S104 3/16" = 1'-0"