

SEALS  
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NOTES  
1. WORK WITH THE EXISTING SPRINKLER SYSTEM TO PROVIDE A COMPLETELY DESIGNED AUTOMATIC WET SPRINKLER SYSTEM FOR ALL RENOVATED/UPPIT AREAS OF WORK. SYSTEM SHALL BE IN ACCORDANCE WITH NFPA 13 AND THE STATE FIRE MARSHAL REQUIREMENTS. THE EXISTING MAIN BRANCH SPRINKLER PIPING WITHIN THE AREA OF WORK SHALL BE REMOVED SUCH THAT THE PROGRAM AREAS OUTSIDE AREAS OF WORK HAVE CONTINUED FIRE PROTECTION. TEMPORARY PIPING SHALL BE PROVIDED AS REQUIRED. PRIOR TO INSTALLATION, NEW SPRINKLER PIPING SHALL BE FULLY COORDINATED WITH HVAC AND ELECTRICAL SERVICES.

GENERAL NOTES  
1. REFER TO FP101 FOR GENERAL NOTES.  
2. REFER TO DRAWING FP011 AND FP012 FOR EXISTING FIRST FLOOR AND CRAWL SPACE FIRE PROTECTION LAYOUT (FOR REFERENCE ONLY).

 **MUSC**  
MEDICAL UNIVERSITY  
of SOUTH CAROLINA  
PROJECT NUMBER: H51-50068  
DHEC PROJECT NUMBER: 580145


**CONSTRUCTION DOCUMENTS**

STORM EYE INSTITUTE  
OPTICAL SHOP  
H51-50068  
167 ASHLEY AVE  
CHARLESTON, SC 29425

 **ROSENBLUM COE ARCHITECTS, INC.**  
1643 MEANS STREET  
CHARLESTON, SC 29412  
843.577.6073

**FIRE PROTECTION FLOOR PLAN**

SHEET NAME	
PROJECT NUMBER	17016
DRAWN BY	TSN
CHECKED BY	CRB
DATE	05/09/2018
SCALE	1/4" = 1'-0"
<b>FP101</b>	

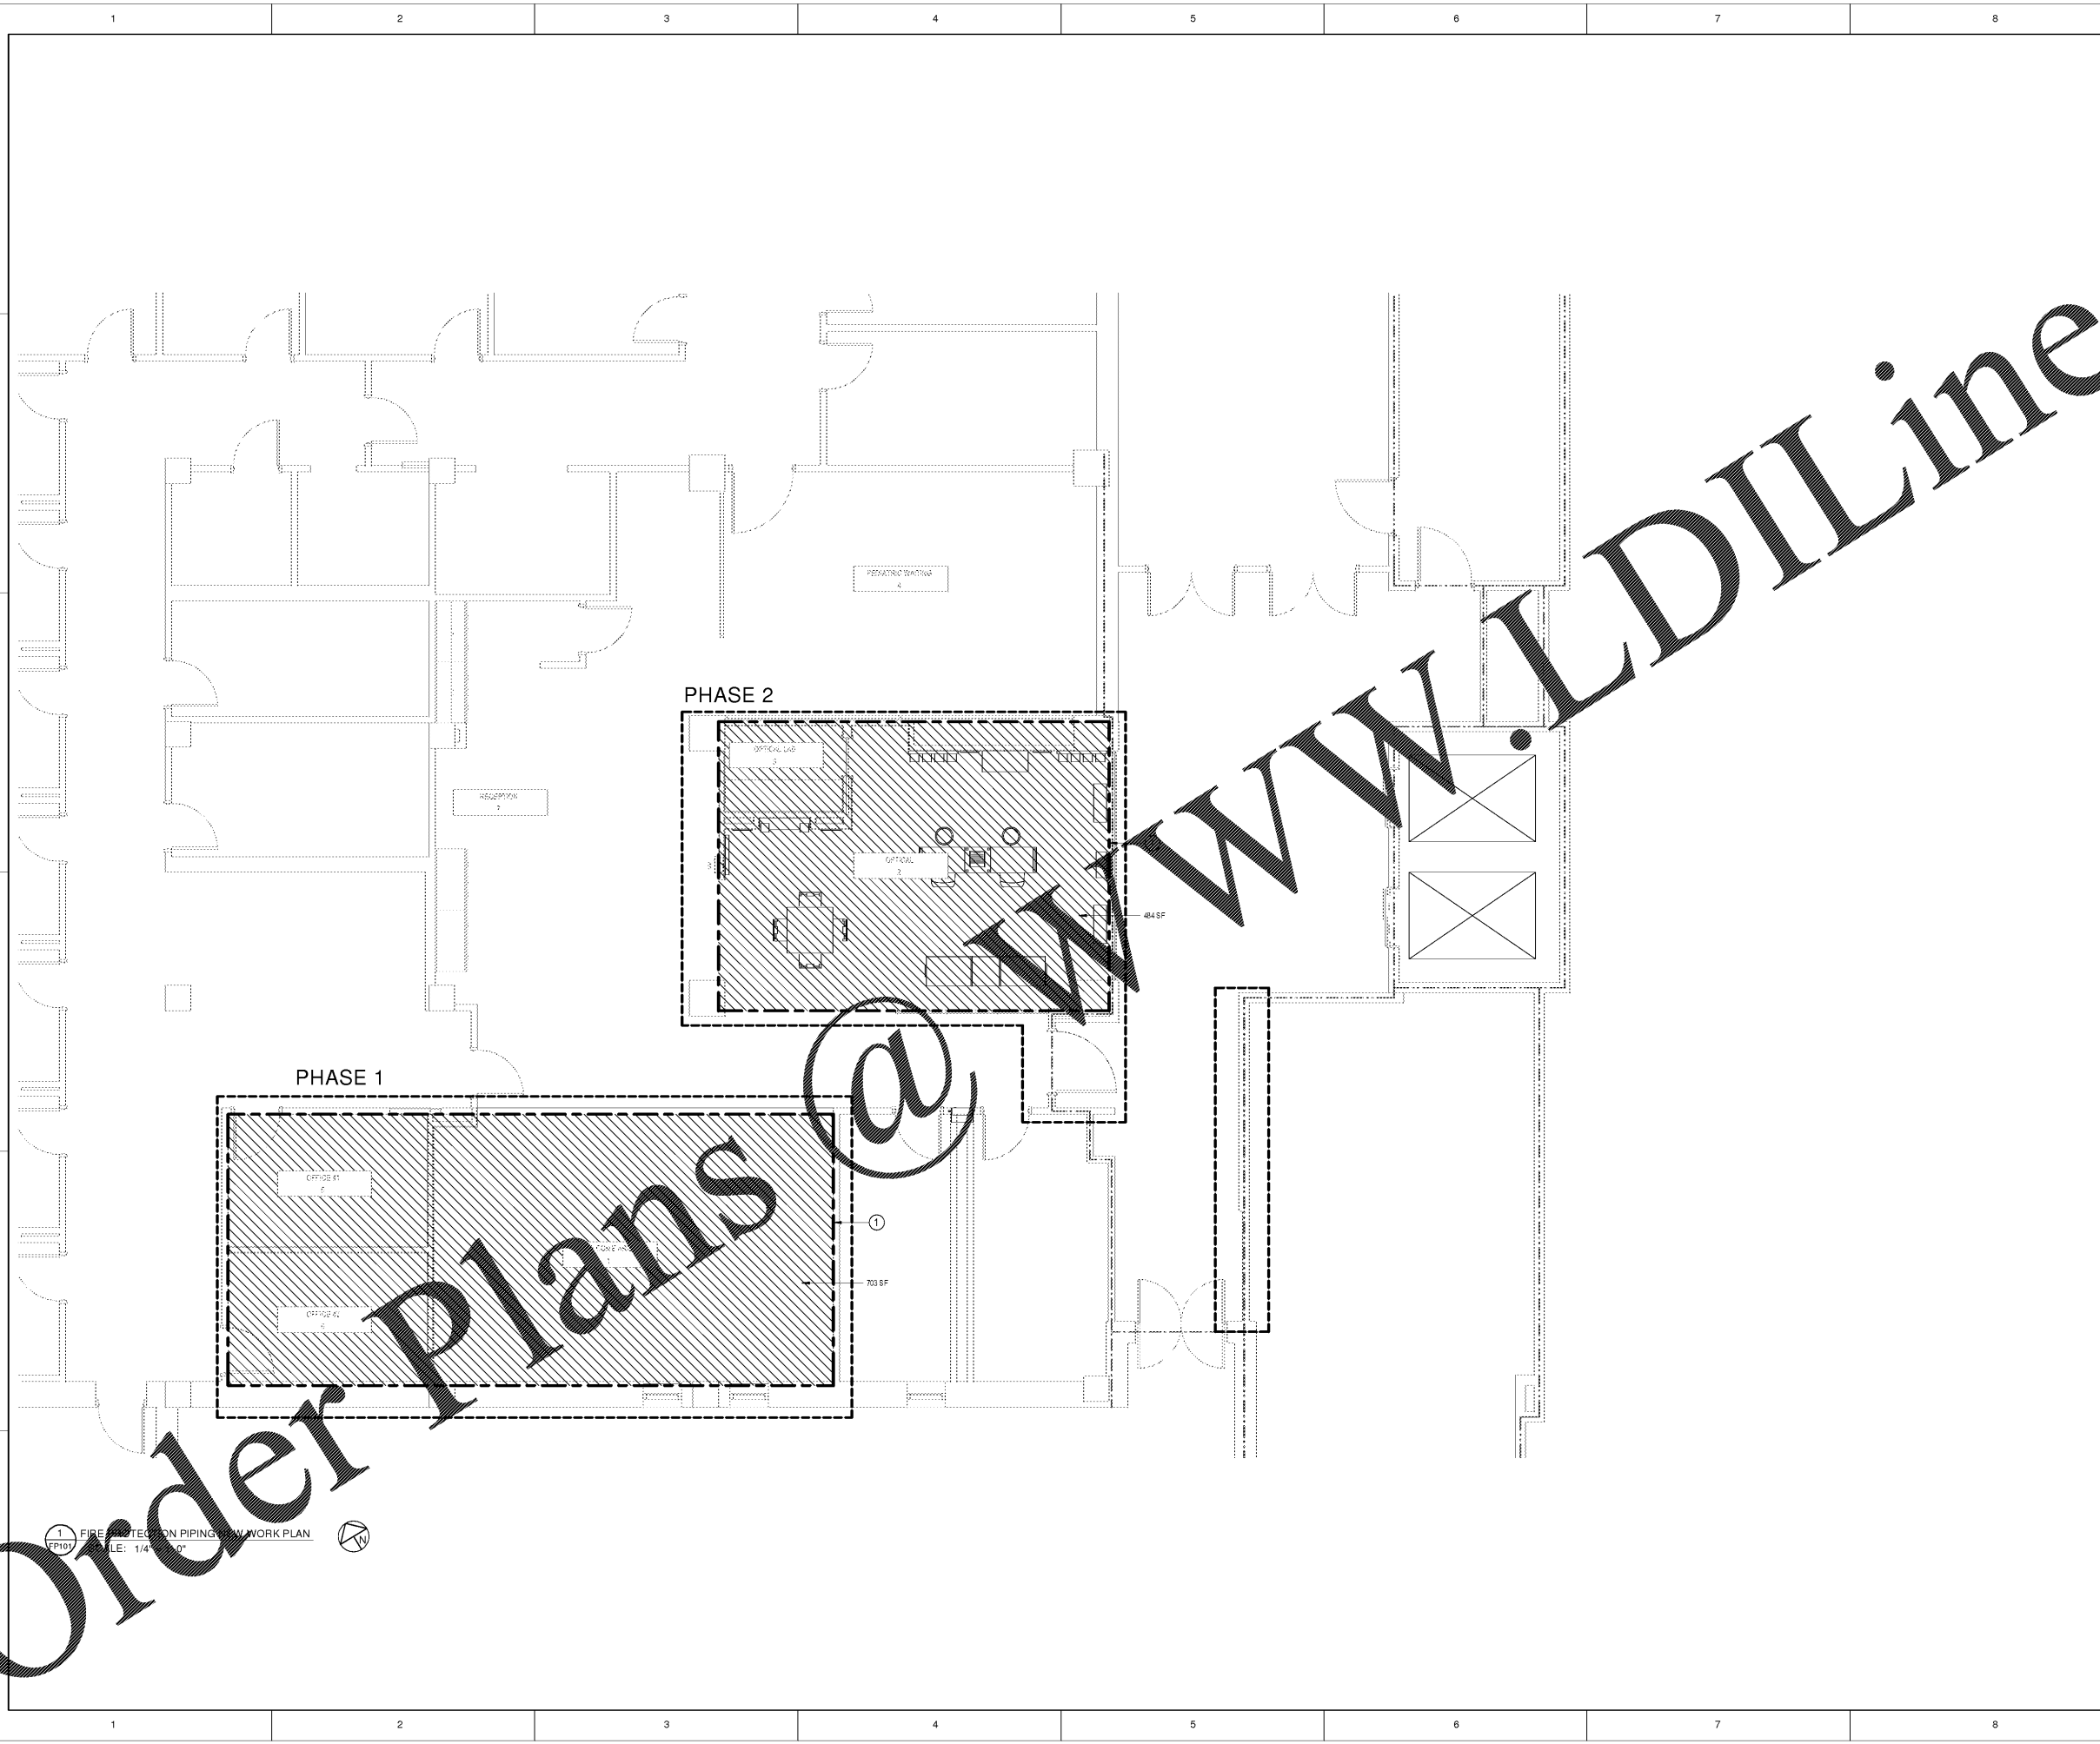

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1 FIRE PROTECTION PIPING WORK PLAN  
SCALE: 1/4" = 1'-0"