



SEALS
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NOTE
1. WORK ON THE EXISTING SPRINKLER SYSTEM TO PROVIDE A COMPLETELY DESIGNED AUTOMATIC WET SPRINKLER SYSTEM FOR ALL RENOVATED/UPPIT AREAS OF WORK. SYSTEM SHALL BE IN ACCORDANCE WITH NFPA 13 AND THE STATE FIRE MARSHAL REQUIREMENTS. THE EXISTING MAIN BRANCH SPRINKLER PIPING WITHIN THE AREA OF WORK SHALL BE REMOVED SUCH THAT THE PROGRAM AREAS OUTSIDE AREAS OF WORK HAVE CONTINUED FIRE PROTECTION. TEMPORARY PIPING SHALL BE PROVIDED AS REQUIRED. PRIOR TO INSTALLATION, NEW SPRINKLER PIPING SHALL BE FULLY COORDINATED WITH HVAC AND ELECTRICAL SERVICES.

GENERAL NOTES
1. REFER TO FP001 FOR GENERAL NOTES.
2. REFER TO DRAWING FP001 AND FP002 FOR EXISTING FIRST FLOOR AND CRAWL SPACE FIRE PROTECTION LAYOUT (FOR REFERENCE ONLY).

 **MUSC**
MEDICAL UNIVERSITY
of SOUTH CAROLINA
PROJECT NUMBER: H51-50068
DHEC PROJECT NUMBER: 580145


CONSTRUCTION DOCUMENTS

STORM EYE INSTITUTE
OPTICAL SHOP
H51-50068
167 ASHLEY AVE
CHARLESTON, SC 29425

 **ROSENBLUM COE ARCHITECTS, INC.**
1643 MEANS STREET
CHARLESTON, SC 29412
843.577.6073

FIRE PROTECTION FLOOR PLAN

SHEET NAME	
PROJECT NUMBER	17016
DRAWN BY	TSN
CHECKED BY	CRB
DATE	05/09/2018
SCALE	1/4" = 1'-0"
FP101	

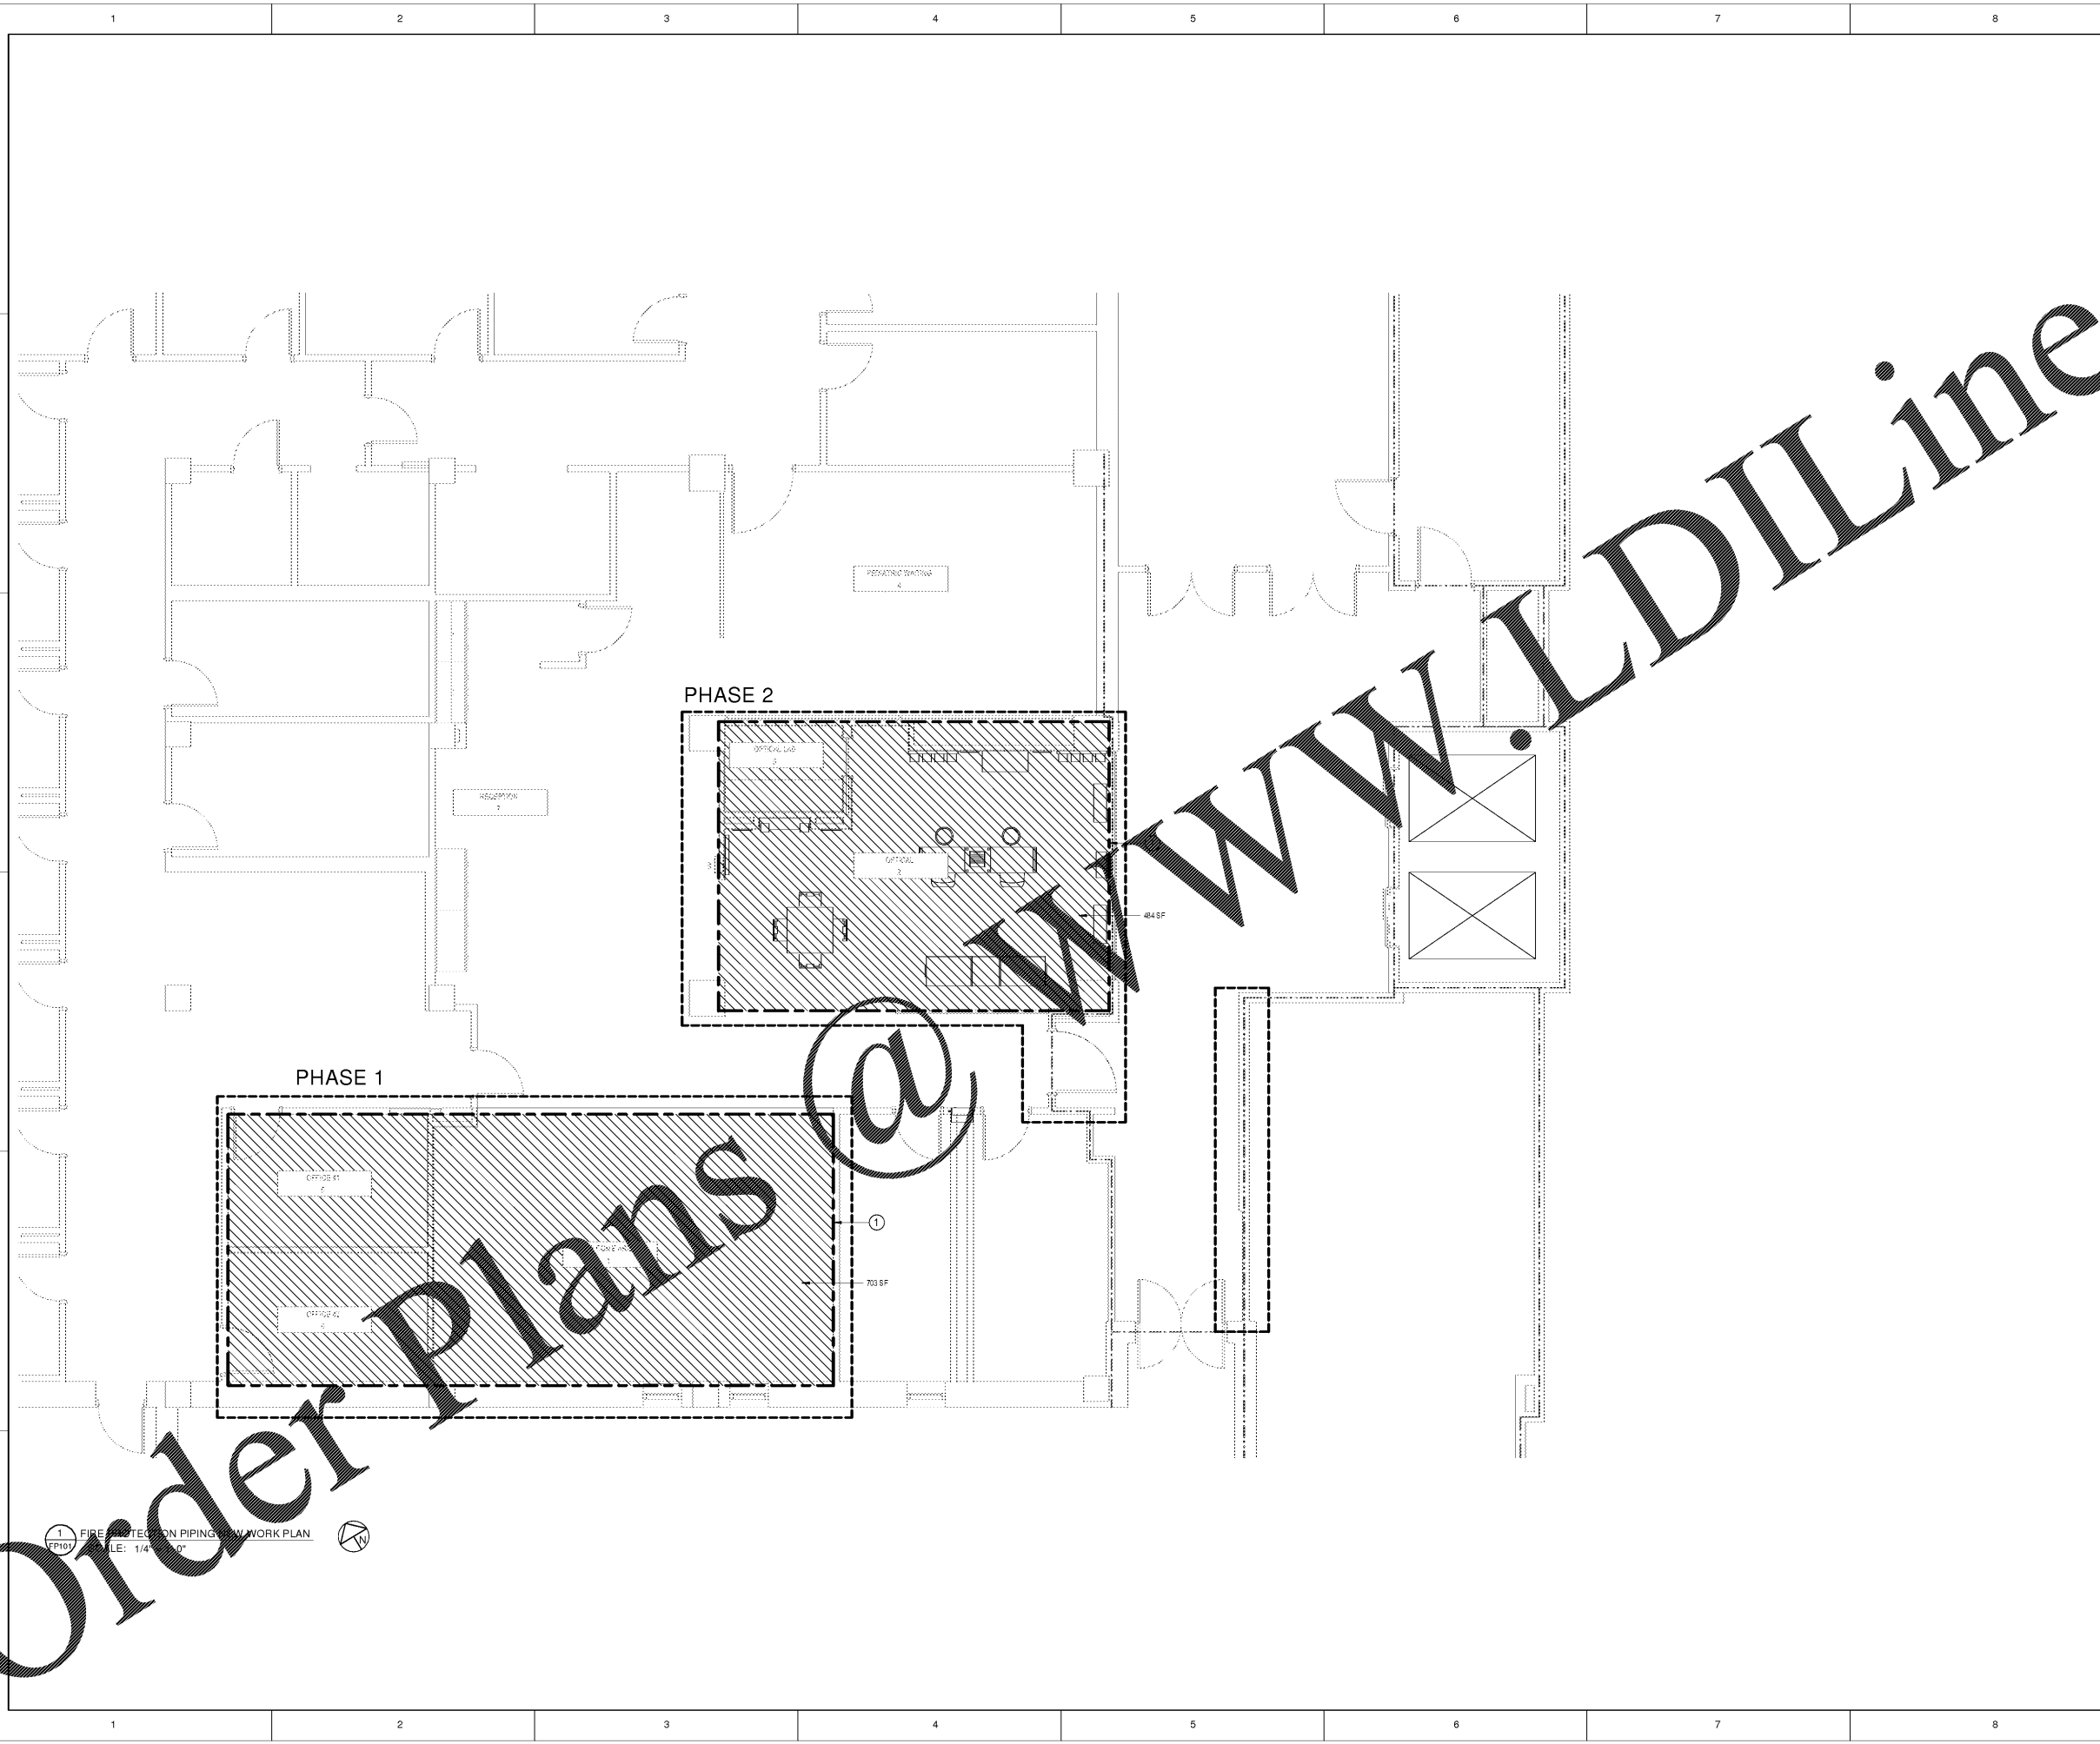

1 FIRE PROTECTION PIPING WORK PLAN
SCALE: 1/4" = 1'-0"

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