


# Order Plans

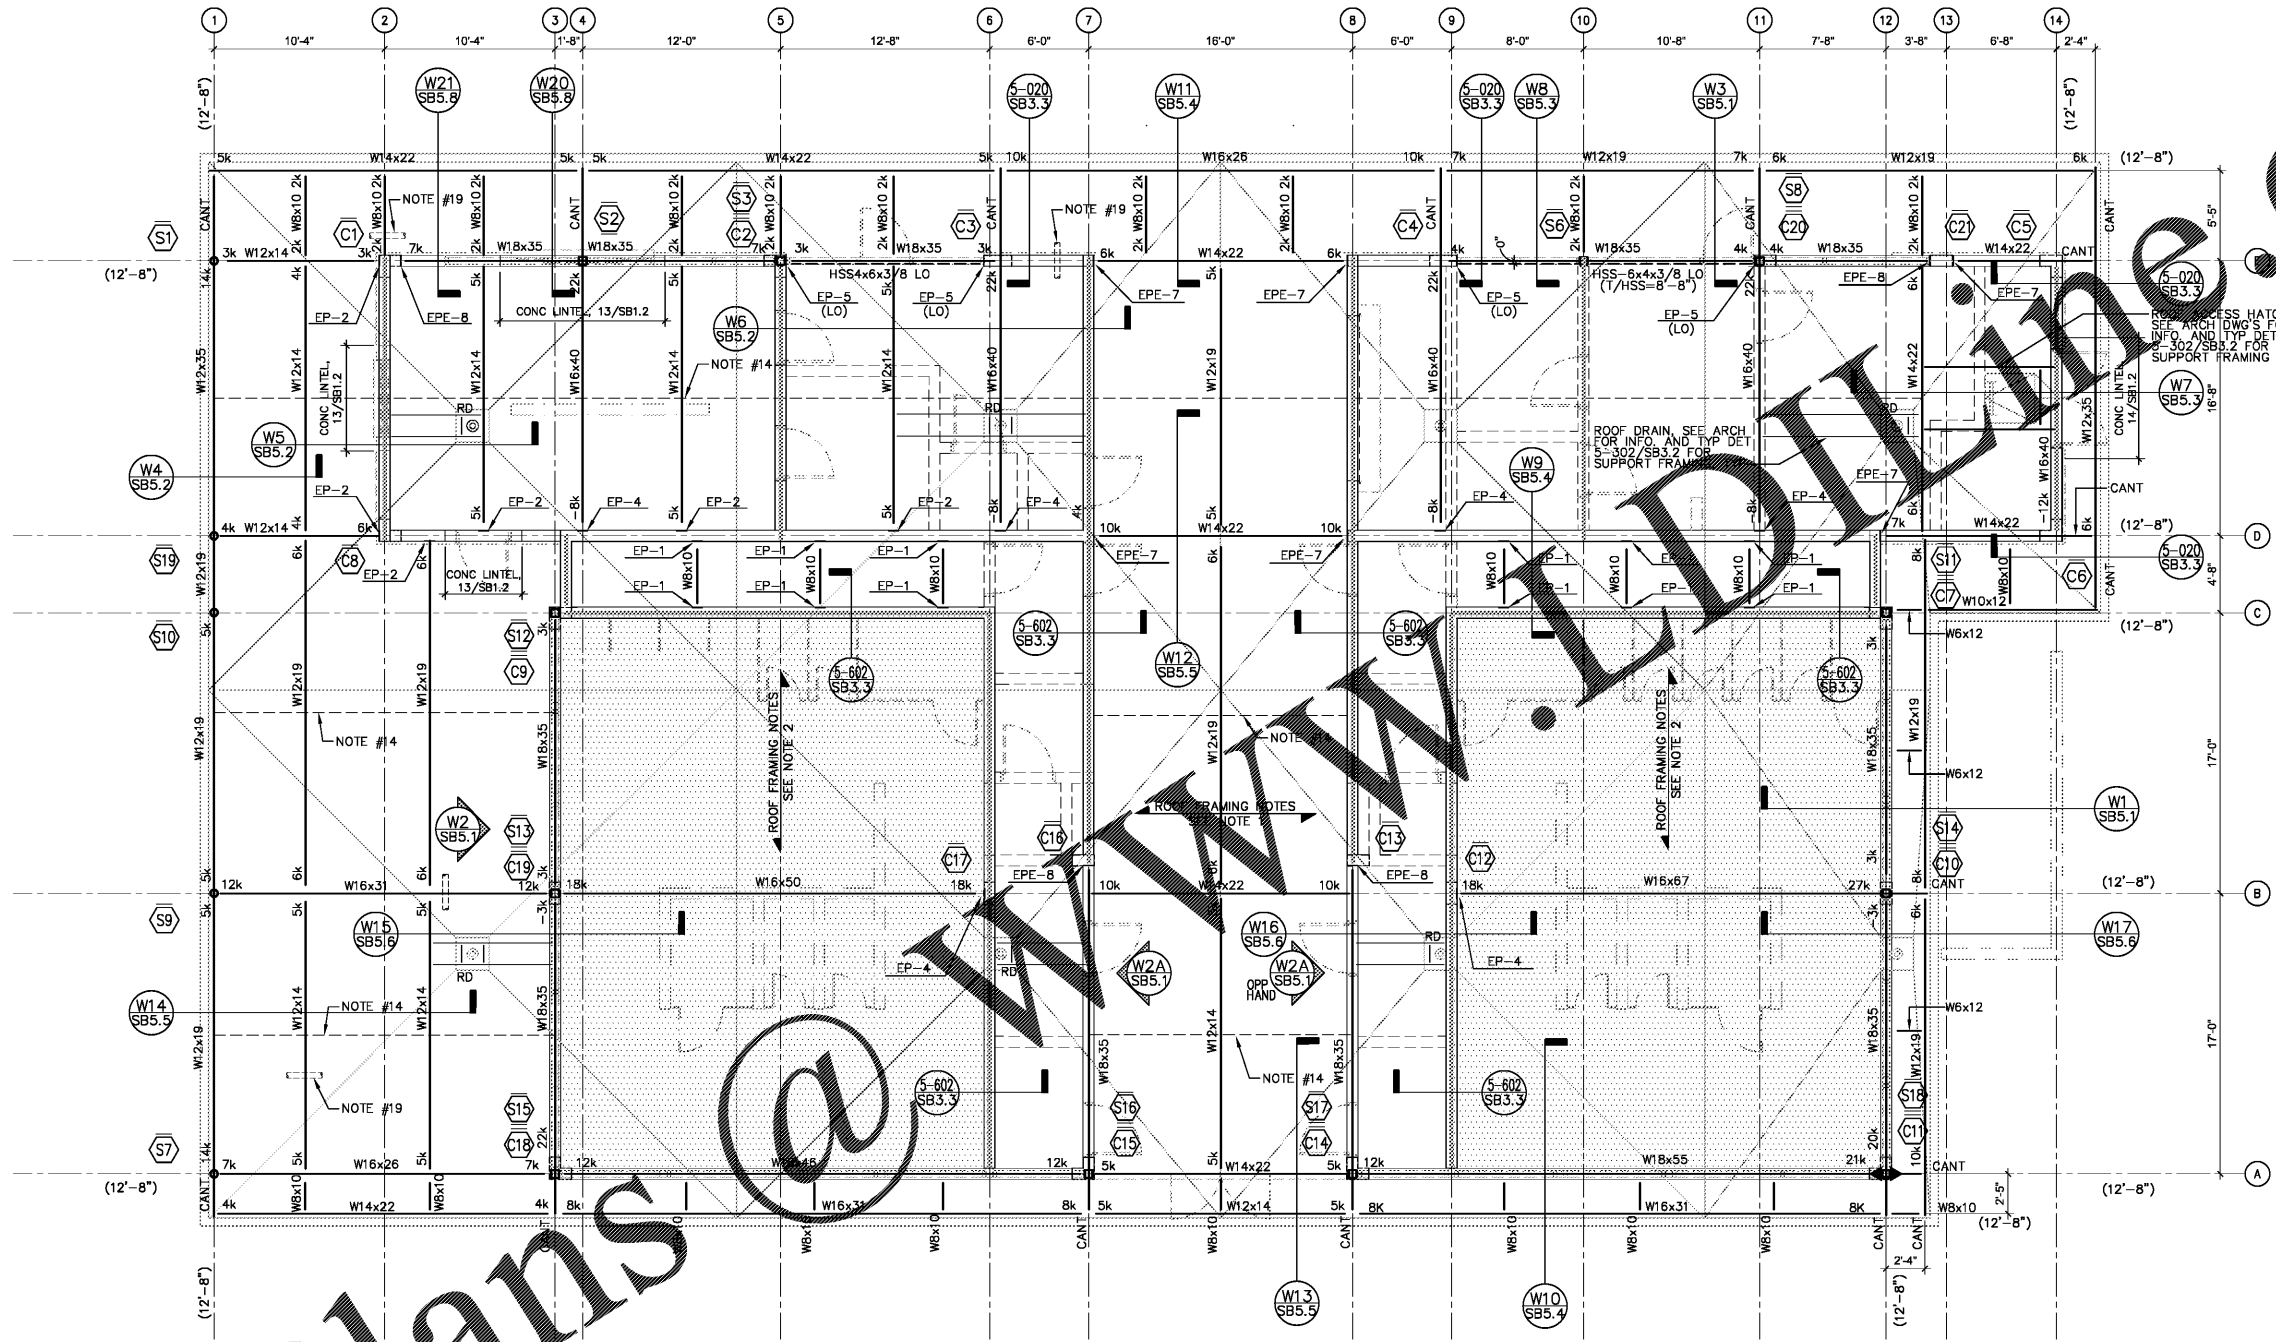

**1 ROOF FRAMING PLAN**  
SCALE: 3/16" = 1'-0"

**ROOF FRAMING NOTES:**

- ROOF FRAMING SHALL BE 3" - 20 GAGE TYPE "N" METAL DECK SPANNING OVER STEEL BEAMS SPACED AT @ 10'-0" O.C. (U.N.O.).
- ROOF FRAMING SHALL BE 3 1/2" - 16 GAGE TYPE "LS" ACOUSTIC VERSA-DEK SPANNING OVER STEEL BEAMS SPACED AT @ 16'-0" O.C. (U.N.O.).
- DIRECTION OF METAL DECK SPAN SHOWN THIS  $\rightarrow$  ON PLAN. FOR ROOF DRAIN LOCATIONS AND SIZE SEE ARCHITECTURAL DRAWINGS.
- PROVIDE PENETRATION IN STEEL BEAM WEB FOR 4" DIAMETER RAIN LEADER PIPES. SEE TYPICAL DETAIL 5-100/SB3.3 FOR REQUIRED INFORMATION. COORDINATE RAIN LEADER PIPE LAYOUT WITH PLUMBING DRAWINGS. IF LAYOUT VARIES FROM LAYOUT SHOWN ON THIS PLAN AT STEEL BEAM WEB PENETRATIONS THE CONTRACTOR SHALL CONTACT THE ENGINEER OF RECORD.
- PROVIDE PENETRATION IN STEEL BEAM WEB FOR SPRINKLER PIPES. SEE TYPICAL DETAIL 5-100/SB3.3 FOR REQUIRED INFORMATION. COORDINATE SPRINKLER PIPE LAYOUT AND PIPE DIAMETER/S WITH PLUMBING DRAWINGS. IF LAYOUT VARIES FOR LAYOUT SHOWN ON THIS PLAN AT STEEL BEAM WEB PENETRATIONS THE CONTRACTOR SHALL CONTACT THE ENGINEER OF RECORD.
- CONTRACTOR TO COORDINATE ALL REVEALS, SILLS ETC. WITH ARCHITECTURAL DRAWINGS.
- PIPE OPENING THROUGH WIDE FLANGE BEAM. SEE TYPICAL DETAIL 5-100 ON DRAWING SB3.3.
- FOR LOAD SCHEDULE & WIND DESIGN DATA, SEE DRAWING SB1.1.
- L2X2X4 BOTTOM FLANGE BRACING.
- STEEL PLATE EMBED SHOWN THIS  $\rightarrow$  ON PLAN. SEE TYPICAL DETAIL 5-005/SB3.3 FOR BEAM CONNECTIONS AT FACE OF WALL AND 5-006 FOR BEAM AT WALL CORNER OR END WALL CONDITION.
- PROVIDE PENETRATION IN STEEL BEAM WEB FOR 4" DIAMETER RAIN LEADER PIPES. SEE TYPICAL DETAIL 5-100/SB3.3 FOR REQUIRED INFORMATION. COORDINATE RAIN LEADER PIPE LAYOUT WITH PLUMBING DRAWINGS. IF LAYOUT VARIES FROM LAYOUT SHOWN ON THIS PLAN AT STEEL BEAM WEB PENETRATIONS THE CONTRACTOR SHALL CONTACT THE ENGINEER OF RECORD.
- PROVIDE PENETRATION IN STEEL BEAM WEB FOR SPRINKLER PIPES. SEE TYPICAL DETAIL 5-100/SB3.3 FOR REQUIRED INFORMATION. COORDINATE SPRINKLER PIPE LAYOUT AND PIPE DIAMETER/S WITH PLUMBING DRAWINGS. IF LAYOUT VARIES FOR LAYOUT SHOWN ON THIS PLAN AT STEEL BEAM WEB PENETRATIONS THE CONTRACTOR SHALL CONTACT THE ENGINEER OF RECORD.
- CONTRACTOR TO COORDINATE ALL REVEALS, SILLS ETC. WITH ARCHITECTURAL DRAWINGS.
- PIPE OPENING THROUGH WIDE FLANGE BEAM. SEE TYPICAL DETAIL 5-100 ON DRAWING SB3.3.

**WALL LEGEND**

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ROOF DRAIN AND RAIN LEADER, SEE PLUMBING DRAWINGS

Continuously Digitally signed by JAMES R MEHLTRETTER  
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1=A01098000000158F46F2F  
600000CB7,CN=JAMES R  
MEHLTRETTER, O=IdenTrust  
ACES Unaffiliated Individual,  
C=US  
Date: 2017.12.15  
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Scale: AS SHOWN  
Designed by: SL  
Drawn by: JW  
Checked by: JRM  
Date: DECEMBER 2017  
Project No. 48285014

**BATHHOUSE BUILDING  
ROOF FRAMING PLAN**

**BUTLER PARK  
AQUATIC CENTER  
CITY OF NORTHPORT, FL**



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SHEET  
**SB2.2**