



SECTION

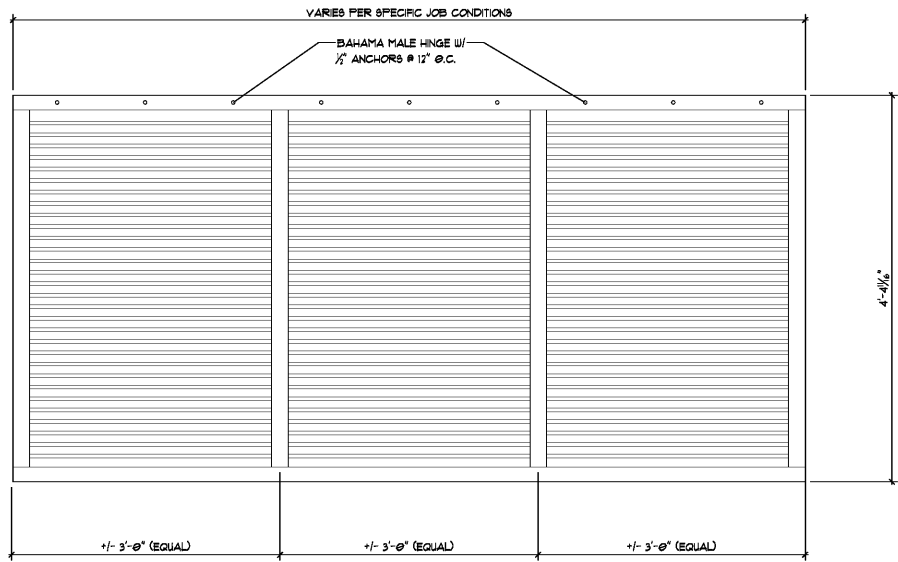


ELEVATION

3 BAHAMA SHUTTER DETAIL
1" = 1'-0"

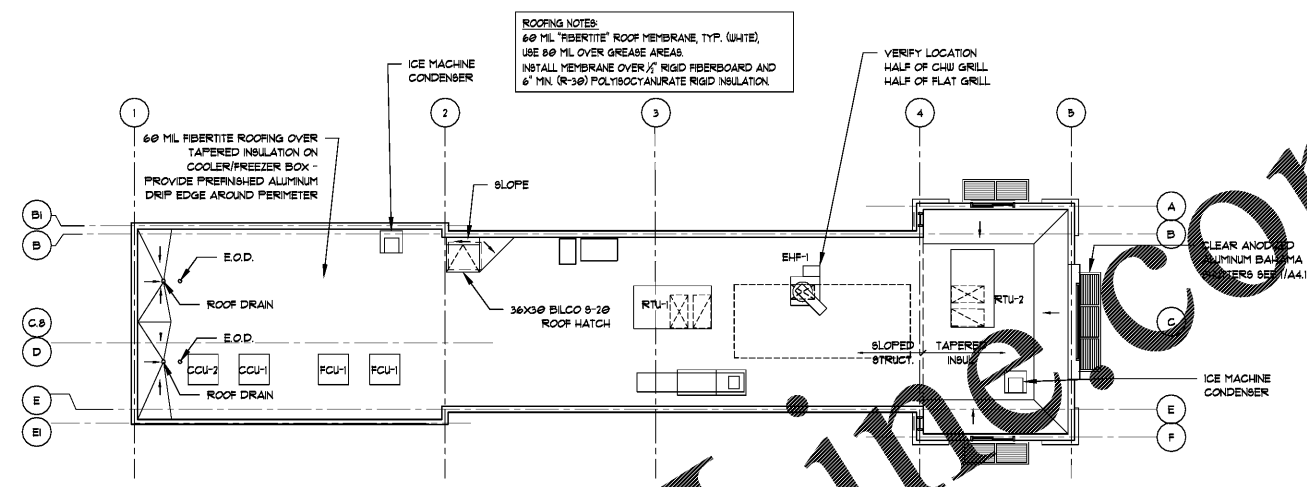

2 ROOF PLAN
SCALE: 1/8" = 1'-0"

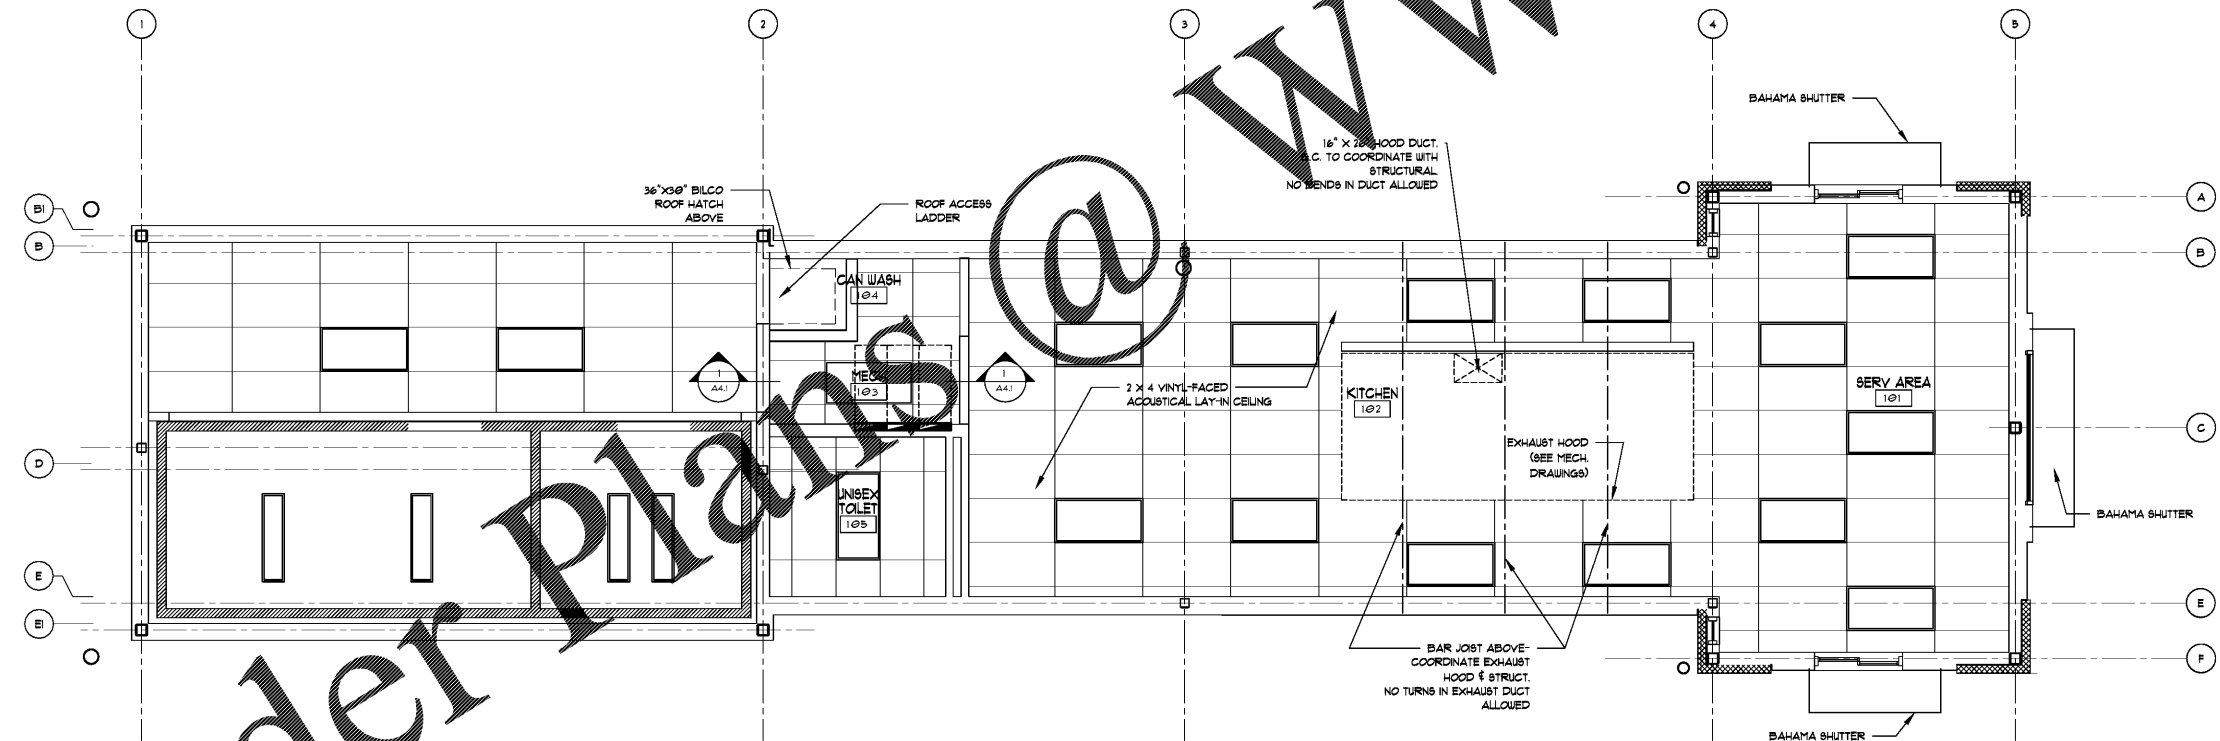


REFLECTED CEILING PLAN
SCALE: 1/4" = 1'-0"

- CEILING PLAN NOTES**
- 2' x 4' VINYL FACED ACOUSTICAL LAY-IN GRID, TYPICAL
 - CEILING HEIGHTS VARY, SEE ROOM FINISH SCHEDULE
 - LIGHTS SHOWN FOR REFERENCE ONLY. SEE ELECTRICAL DRAWINGS FOR LIGHTING PLAN

- GENERAL CEILING PLAN NOTES**
- THE ARCHITECTURAL REFLECTED CEILING PLAN IS PROVIDED FOR GENERAL COORDINATION OF CEILING ITEMS PROVIDED BY THE MECHANICAL AND ELECTRICAL CONTRACTORS. MINOR INCONSISTENCIES IN DESIGNATIONS OR UNOVERTENT OMISSIONS ON THE REFLECTED CEILING PLANS DO NOT CONSTITUTE DELETION OF ANY ITEM PROVIDED BY THE OTHER CONTRACTORS. THE MECHANICAL AND ELECTRICAL DRAWINGS SHALL DICTATE THE SCOPE OF WORK PROVIDED BY THOSE CONTRACTORS.
 - REFER TO ROOM FINISH SCHEDULE AND BUILDING AND/OR WALL SECTIONS FOR MORE INFORMATION REGARDING CEILING TYPES, HEIGHTS, ETC.

LINDSEY ARCHITECTURE
25 S. Elm Street, Suite 300
Greensboro, NC 27401
P: 336.817.4434
www.lindsayarchitecture.com

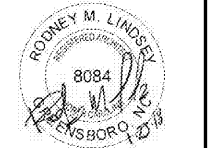

COOK OUT PEMBROKE
601 West 3rd Street
Pembroke, NC

CHK	DATE	DESCRIPTION

REFLECTED CEILING PLAN

DATE: 1-23-2018
DRAWN BY: CVT
CHECK BY: ---
JOB NO.: 11-103
SHEET:



A1.2