



4 SW8 - 12" CMU WALL ELEVATION
S4.8 1/4" = 1'-0"

- NOTES:
1. SEE PARTIAL FRAMING PLANS S4.5-S4.7 FOR END WALL REINF REQUIREMENTS.
 2. PROVIDE 9 GA LADDER REINF @16"OC HORIZ, UNO.
 3. SEE S4.0 AND S4.1 FOR TYPICAL CMU DETAILS.
 4. SEE OTHER SECTIONS AND DETAILS FOR BOND BEAM REQUIREMENTS. MIN 8" DEEP W/ (2)#5 CONT.
 5. ALL SHEAR WALL CELLS SHALL BE GROUTED SOLID.
 6. COORDINATE SIZE AND LOCATIONS OF DOOR AND/OR MECH OPENINGS W/ ARCH/MECH DWGS

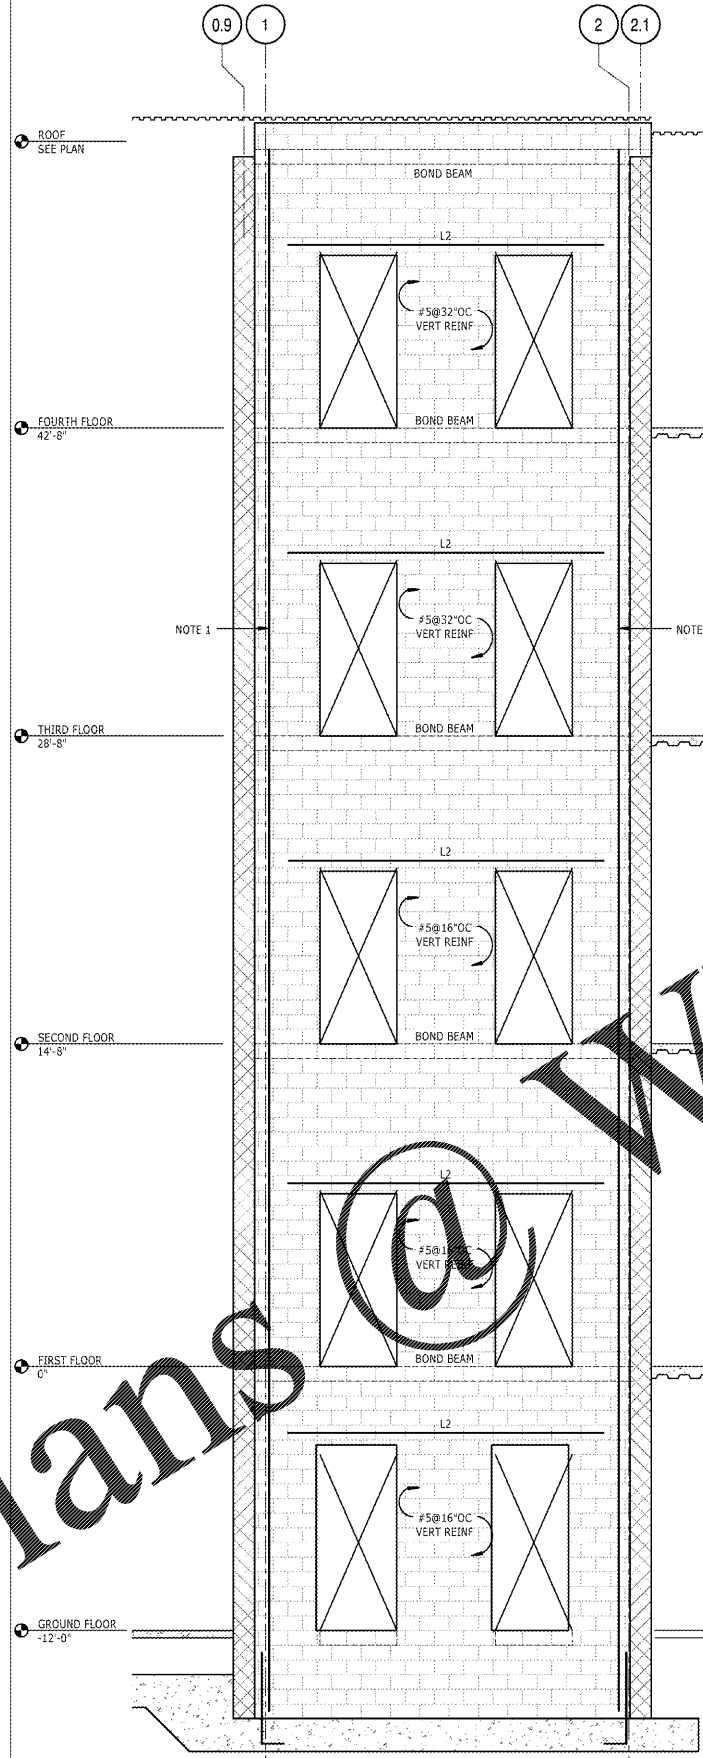


3 SW7 - 12" CMU WALL ELEVATION
S4.8 1/4" = 1'-0"

- NOTES:
1. SEE PARTIAL FRAMING PLANS S4.5-S4.7 FOR END WALL REINF REQUIREMENTS.
 2. PROVIDE 9 GA LADDER REINF @16"OC HORIZ, UNO.
 3. SEE S4.0 AND S4.1 FOR TYPICAL CMU DETAILS.
 4. SEE OTHER SECTIONS AND DETAILS FOR BOND BEAM REQUIREMENTS. MIN 8" DEEP W/ (2)#5 CONT.
 5. ALL SHEAR WALL CELLS SHALL BE GROUTED SOLID.

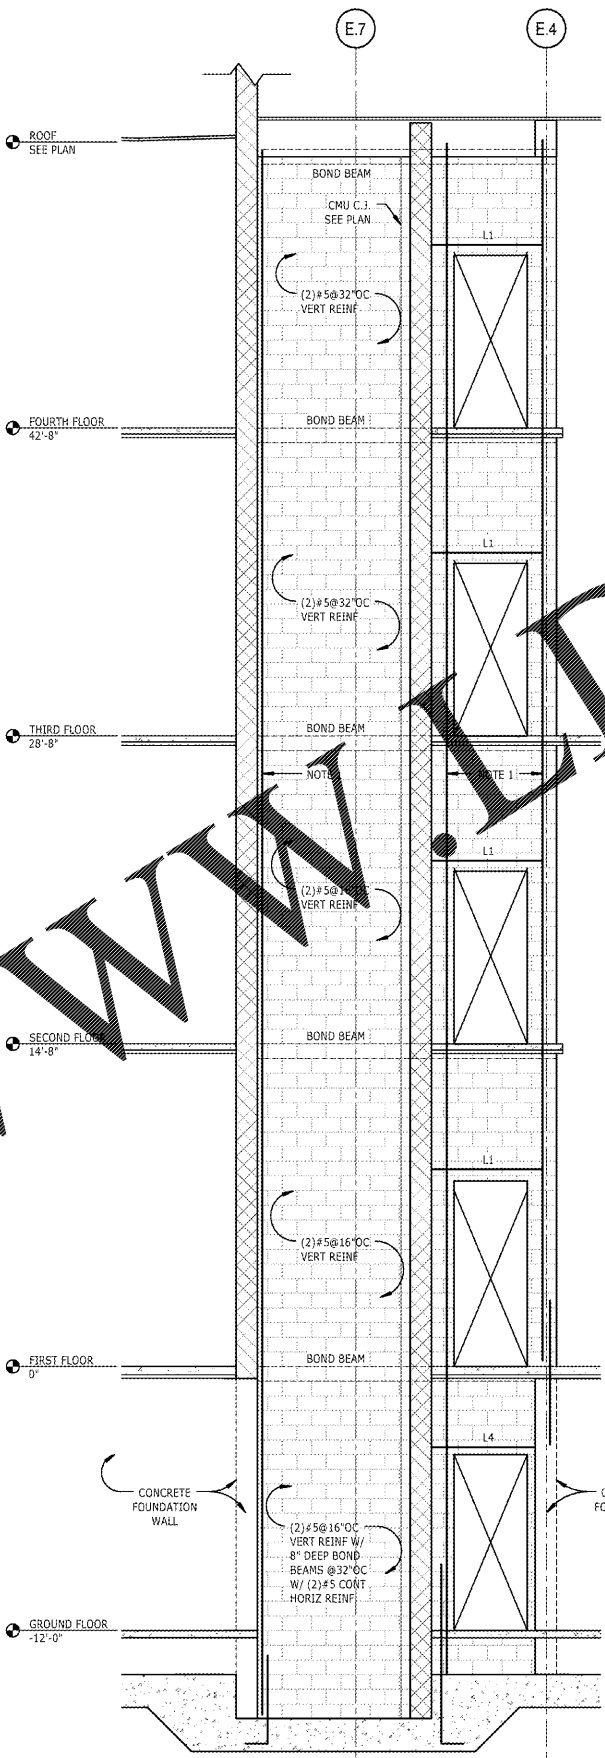

2 SW6 - 12" CMU WALL ELEVATION
S4.8 1/4" = 1'-0"

- NOTES:
1. SEE PARTIAL FRAMING PLANS S4.5-S4.7 FOR END WALL REINF REQUIREMENTS.
 2. PROVIDE 9 GA LADDER REINF @16"OC HORIZ, UNO.
 3. SEE S4.0 AND S4.1 FOR TYPICAL CMU DETAILS.
 4. SEE OTHER SECTIONS AND DETAILS FOR BOND BEAM REQUIREMENTS. MIN 8" DEEP W/ (2)#5 CONT.
 5. ALL SHEAR WALL CELLS SHALL BE GROUTED SOLID.
 6. COORDINATE SIZE AND LOCATIONS OF DOOR AND/OR MECH OPENINGS W/ ARCH/MECH DWGS

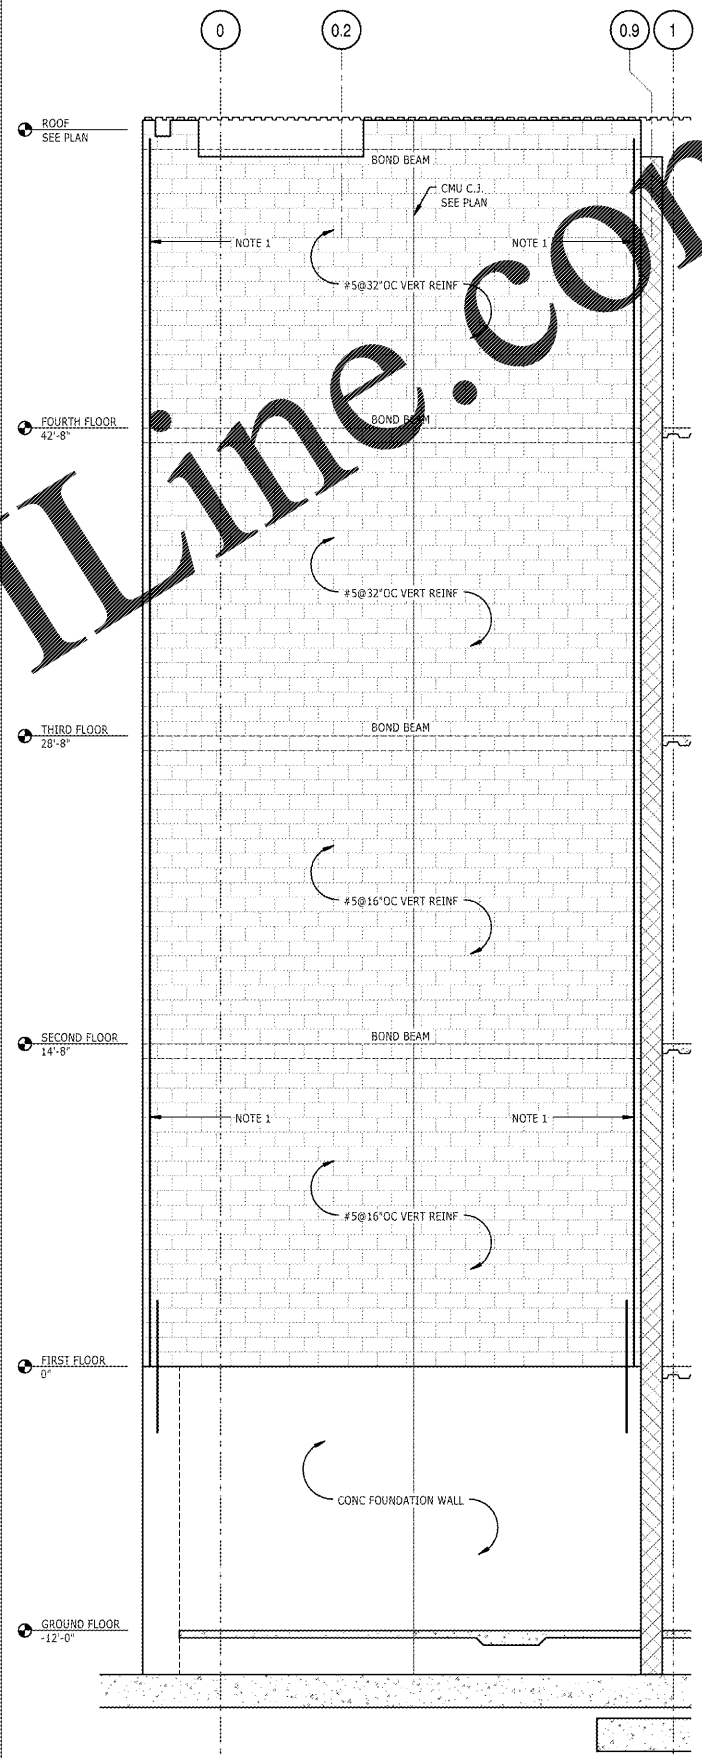


1 SW5 - 12" CMU WALL ELEVATION
S4.8 1/4" = 1'-0"

- NOTES:
1. SEE PARTIAL FRAMING PLANS S4.5-S4.7 FOR END WALL REINF REQUIREMENTS.
 2. PROVIDE 9 GA LADDER REINF @16"OC HORIZ, UNO.
 3. SEE S4.0 AND S4.1 FOR TYPICAL CMU DETAILS.
 4. SEE OTHER SECTIONS AND DETAILS FOR BOND BEAM REQUIREMENTS. MIN 8" DEEP W/ (2)#5 CONT.
 5. ALL SHEAR WALL CELLS SHALL BE GROUTED SOLID.


/VOLUMES/F/DRIVE/FINLEY DESIGN/PROJECTS/1342 WESTPOINT 2/DRAWINGS/TITLEBLOCKS/1342-X-TB.DWG

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Finley Design PA
7806 nc hwy 751
Suite 110
Durham, NC 27713
919-493-8200
FINLEYDESIGNARCH.COM

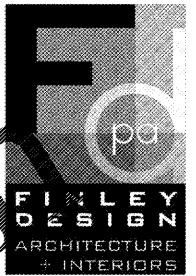

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REVISIONS

NO.	DATE	DESCRIPTION

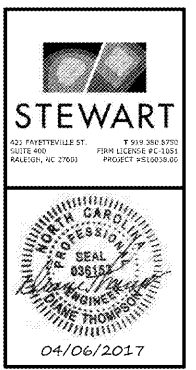PROJECT: S16028.00
DATE: 04/06/2017
DRAWN BY: DR
CHECKED BY: DJT

CMU SHEAR WALL ELEVATIONS

S4.8