


REVISIONS

NO.	DATE	DESCRIPTION

PROJECT: S1000000
DATE: 04/06/2017
DRAWN BY: DR
CHECKED BY: DJT

CMU SHEAR WALL ELEVATIONS

S4.4

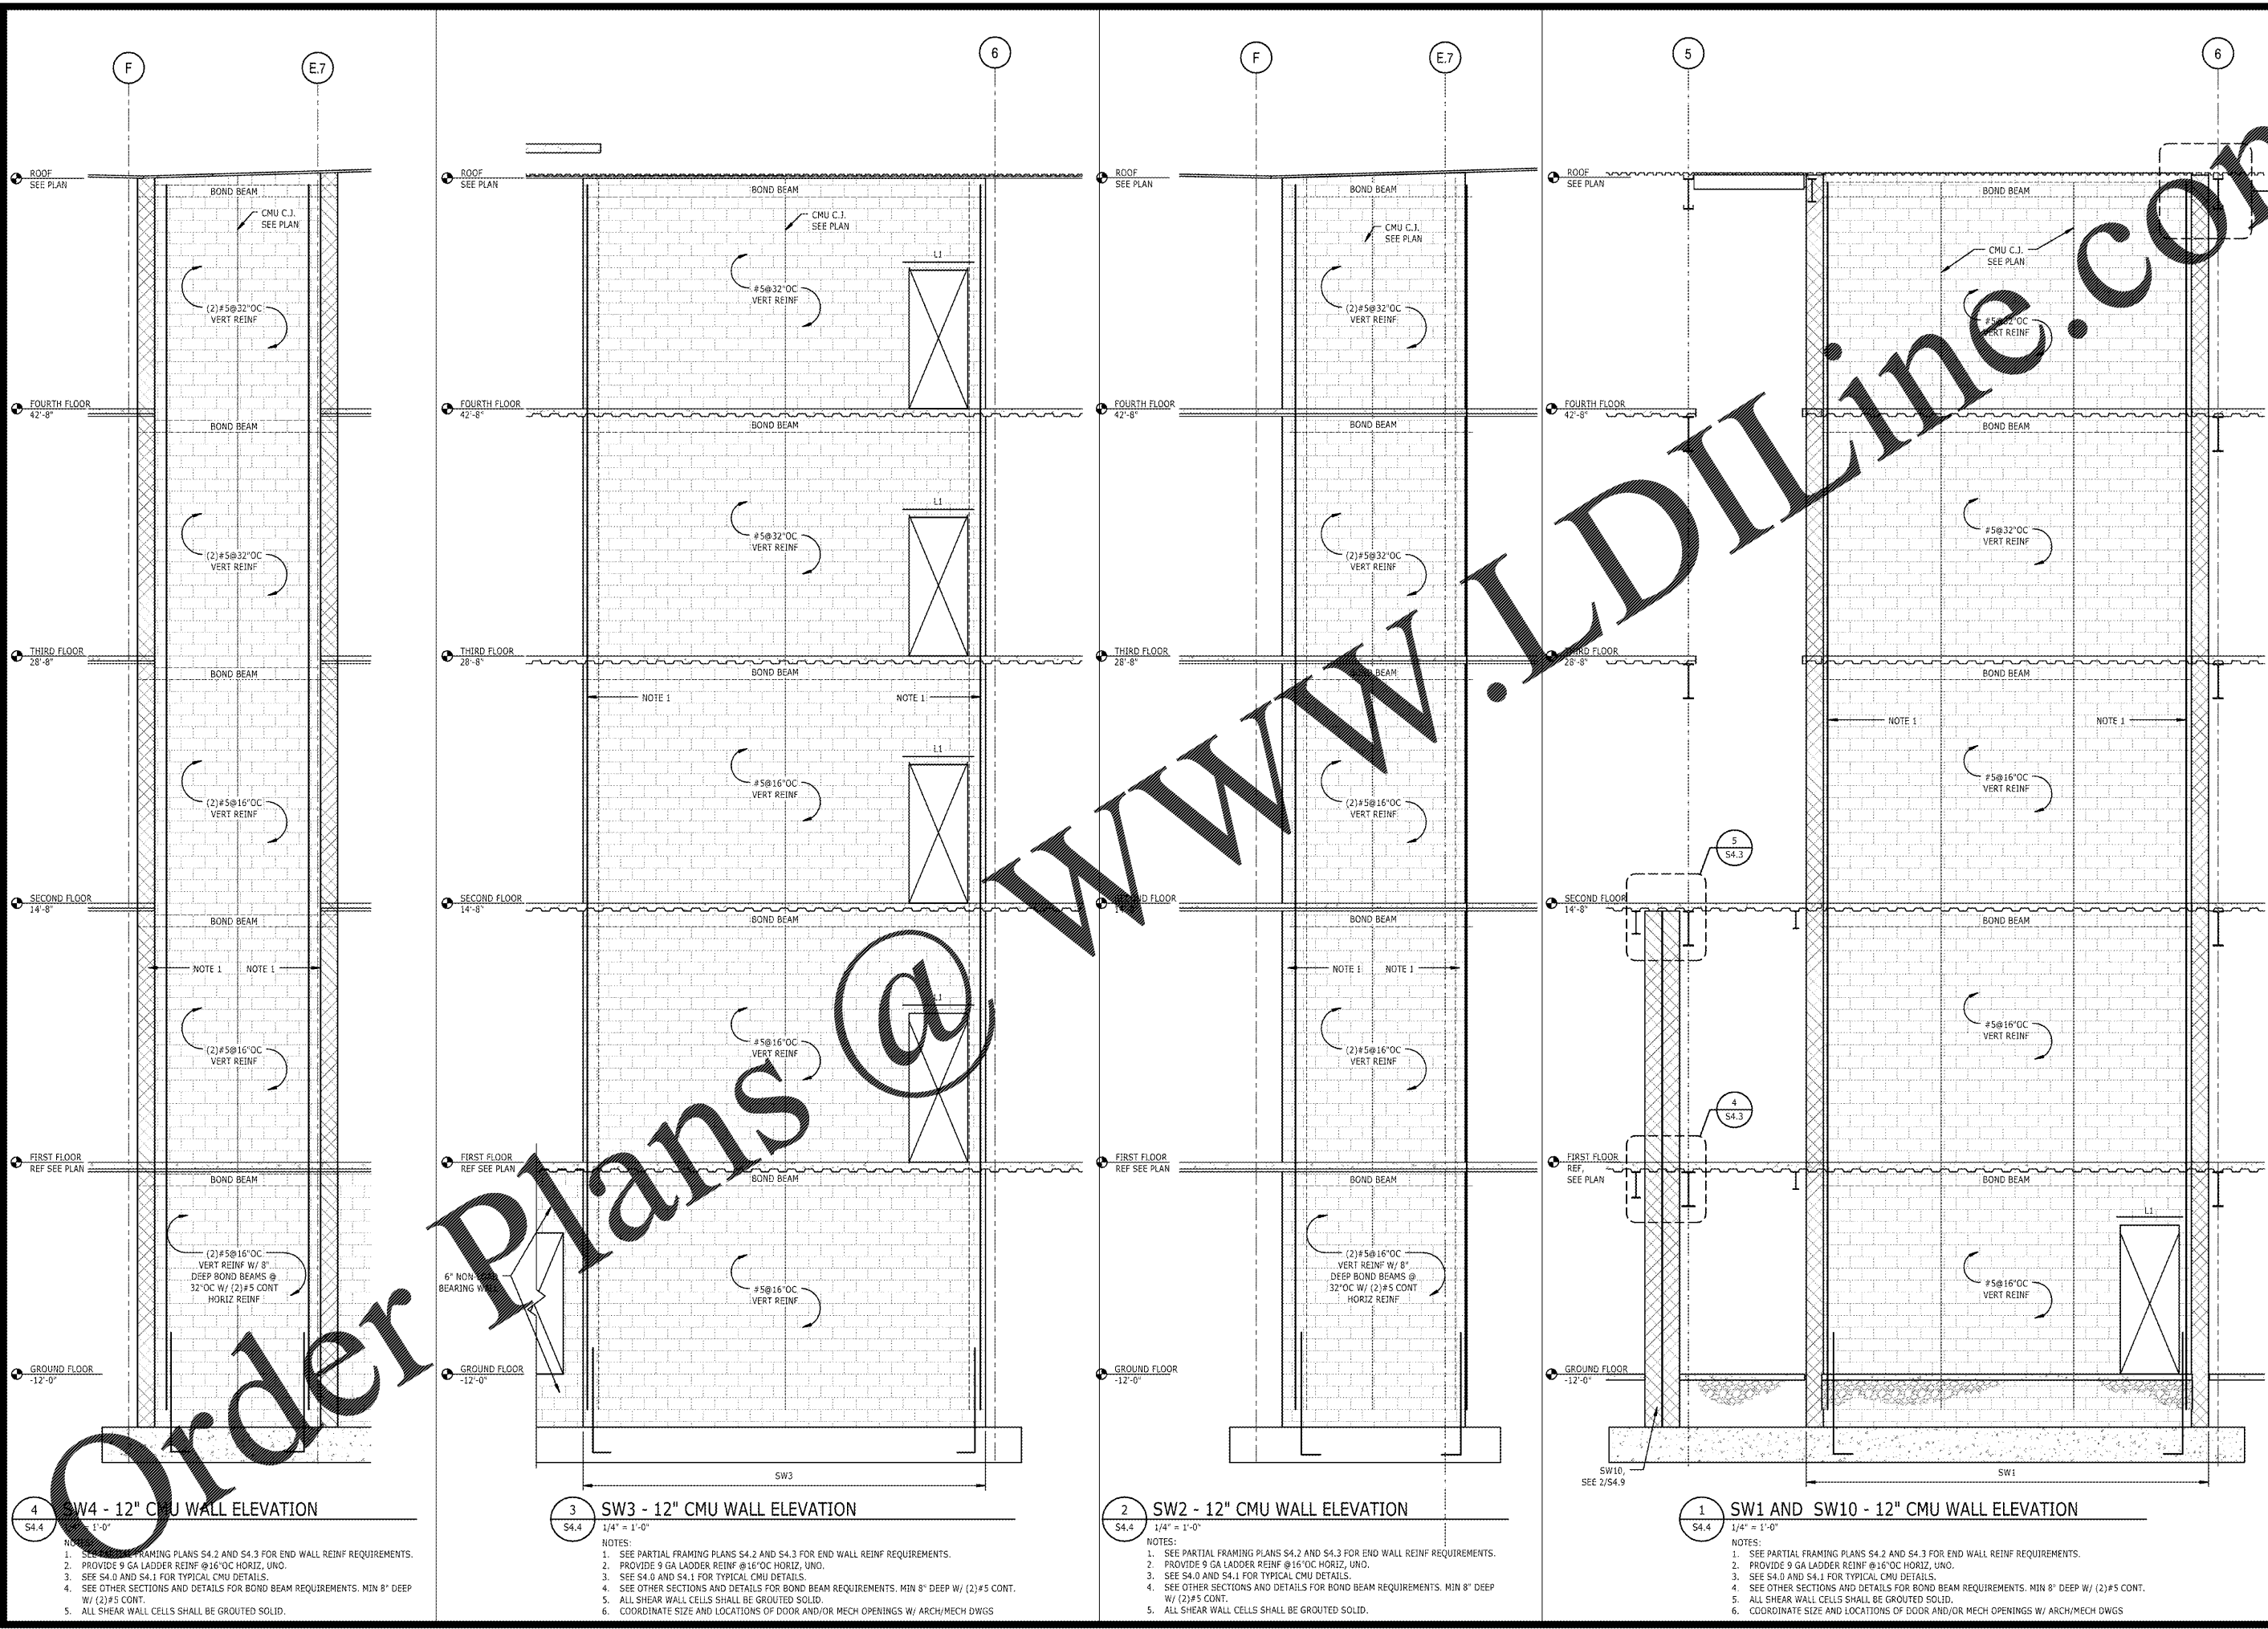

4 S4.4
SW4 - 12" CMU WALL ELEVATION
1/4" = 1'-0"

NOTES:
1. SEE PARTIAL FRAMING PLANS S4.2 AND S4.3 FOR END WALL REINF REQUIREMENTS.
2. PROVIDE 9 GA LADDER REINF @16"OC HORIZ, UNO.
3. SEE S4.0 AND S4.1 FOR TYPICAL CMU DETAILS.
4. SEE OTHER SECTIONS AND DETAILS FOR BOND BEAM REQUIREMENTS. MIN 8" DEEP W/ (2)#5 CONT. W/ (2)#5 CONT.
5. ALL SHEAR WALL CELLS SHALL BE GROUTED SOLID.

3 S4.4
SW3 - 12" CMU WALL ELEVATION
1/4" = 1'-0"

NOTES:
1. SEE PARTIAL FRAMING PLANS S4.2 AND S4.3 FOR END WALL REINF REQUIREMENTS.
2. PROVIDE 9 GA LADDER REINF @16"OC HORIZ, UNO.
3. SEE S4.0 AND S4.1 FOR TYPICAL CMU DETAILS.
4. SEE OTHER SECTIONS AND DETAILS FOR BOND BEAM REQUIREMENTS. MIN 8" DEEP W/ (2)#5 CONT.
5. ALL SHEAR WALL CELLS SHALL BE GROUTED SOLID.
6. COORDINATE SIZE AND LOCATIONS OF DOOR AND/OR MECH OPENINGS W/ ARCH/MECH DWGS

2 S4.4
SW2 - 12" CMU WALL ELEVATION
1/4" = 1'-0"

NOTES:
1. SEE PARTIAL FRAMING PLANS S4.2 AND S4.3 FOR END WALL REINF REQUIREMENTS.
2. PROVIDE 9 GA LADDER REINF @16"OC HORIZ, UNO.
3. SEE S4.0 AND S4.1 FOR TYPICAL CMU DETAILS.
4. SEE OTHER SECTIONS AND DETAILS FOR BOND BEAM REQUIREMENTS. MIN 8" DEEP W/ (2)#5 CONT.
5. ALL SHEAR WALL CELLS SHALL BE GROUTED SOLID.

1 S4.4
SW1 AND SW10 - 12" CMU WALL ELEVATION
1/4" = 1'-0"

NOTES:
1. SEE PARTIAL FRAMING PLANS S4.2 AND S4.3 FOR END WALL REINF REQUIREMENTS.
2. PROVIDE 9 GA LADDER REINF @16"OC HORIZ, UNO.
3. SEE S4.0 AND S4.1 FOR TYPICAL CMU DETAILS.
4. SEE OTHER SECTIONS AND DETAILS FOR BOND BEAM REQUIREMENTS. MIN 8" DEEP W/ (2)#5 CONT.
5. ALL SHEAR WALL CELLS SHALL BE GROUTED SOLID.
6. COORDINATE SIZE AND LOCATIONS OF DOOR AND/OR MECH OPENINGS W/ ARCH/MECH DWGS

/VOLUMES/F DRIVE/FINLEY DESIGN/PROJECTS/1342 WESTPOINT 2/DRAWINGS/TITLEBLOCKS/1342-X-TB.DWG

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