


WALL FRAMING MATERIAL LEGEND	
	EXISTING WALL
	METAL FRAMING
	WOOD FRAMING
	CMU
	COOLER / FREEZER WALL
	WALL TYPES

KEY NOTES			
1	BULKHEAD OR SOFFIT ABOVE. SEE REFLECTED CEILING PLAN	9	5/8" CEMENT BACKER BOARD (CBD-1) AT WALLS BEHIND AND ADJACENT TO KITCHEN HOODS
2	ALIGN WALL ABOVE WITH ADJACENT WING WALLS. SEE INTERIOR ELEVATIONS AND WALL SECTIONS	10	WHERE WALLS ARE BUILT BEHIND GLASS, THERE WILL BE SPANDREL UNITS. INSTALL 1/2" METAL STUDS WITH BATT INSULATION AND 5/8" GYPSUM BOARD ON ROOM SIDE. SEE INTERIOR ELEVATIONS FOR FULL HEIGHT AND PARTIAL HEIGHT LOCATIONS. ALSO SEE EXTERIOR ELEVATIONS FOR SPANDREL LOCATIONS.
3	ENCLOSE COLUMN WITH 1/2" METAL STUDS AND 5/8" GYPSUM BOARD ON ROOM SIDE.	11	BRACED WALL AT THIS LOCATION. SEE DETAIL 3E/A103
4	8" METAL STUD CHASE TO HEIGHT OF 13'-11" AFF. FOR 6" DIA PVC PIPE. W/ SODA LINES AND PLUMBING VENT PIPE. SEE DETAIL 1A & 1E ON SHEET A206	12	PROVIDE HORIZONTAL METAL BLOCKING IN WALL BETWEEN HOODS FOR SHELVING. REFER TO KITCHEN EQUIPMENT ELEVATIONS FOR HEIGHTS.
5	36" CLEAR OPENING FOR MOP SINK	13	5/8" CEMENT BACKER BOARD (CBD-1) AT ALL WALLS IN RESTROOMS BEHIND CERAMIC TILE FINISH.
6	AT BACK AND SIDE WALLS OF MOP SINK, PROVIDE 5/8" CEMENT BOARD (CBD-1) UP TO A HEIGHT OF 48" A.F.F. CONTINUE 5/8" PLYWOOD SHEATHING (SHTG-3) ABOVE CEMENT BOARD AT ENTIRE MOP SINK AREA.	14	8" WIDE CONCRETE CURB BELOW ELECTRICAL PANELS. SEE STRUCTURAL AND DETAIL 3E/A206
7	RECESSED FOUNDATION AT WALK-IN BOX. SEE STRUCTURAL AND DETAILS ON SHEET A206. PROVIDE RIGID INSULATION UNDER CONCRETE SLAB AS INDICATED.	15	5/8" PLYWOOD SHEATHING (SHTG-3) BEHIND ELECTRICAL PANELS
8	5/8" MOLD & MOISTURE RESISTANT GYPSUM BOARD (GYB-2) AT WALLS BEHIND AND ADJACENT TO WALK-IN COOLER & FREEZERS	16	CONCRETE PAD FOR WATER HEATER. SEE STRUCTURAL
		17	CONCRETE PAD FOR GREASE WASTE RECOVERY SYSTEM. SEE STRUCTURAL
		18	TOILET PARTITION WALL SIMILAR TO WALL TYPE 'C7'. SEE RESTROOM ELEVATIONS ON SHEET A207 AND DETAIL SBA207 FOR PARTITION WALL DETAIL
		19	PROVIDE 5/8" PLYWOOD SHEATHING (SHTG-3) TO HEIGHT OF 5'-0" (EXCEPT AS INDICATED ON SERVER STATION ELEVATIONS ON SHEET A204 WITH 5/8" CEMENT BACKER BOARD (CBD-1) TO 2'-4" A.F.F. AT EXTERIOR WALL THIS LOCATION
		20	3/8" METAL STUD FRAMING W/ 5/8" PLYWOOD SHEATHING (SHTG-3) ONE SIDE ON TOP OF COOLER/FREEZERS. ALIGN FACE OF SHEATHING W/ EDGE OF COOLER/FREEZER. EXTEND SHEATHING 6" ABOVE CEILING. SEE DETAIL 3D/A4R2
		21	EXISTING 8" BLOCK WALL TO REMAIN. INSTALL NEW 2" METAL STUDS AT 16" O.C. WITH BATT INSULATION. SEE PARTITION TYPE C7 FOR TYPICAL KITCHEN WALL FINISHES
		22	INSTALL WOOD SILLS - SEE WALL SECTION. WD-19S-28-C-8

GENERAL NOTES	
1	REFER TO A101 FOR ADDITIONAL FLOOR PLAN INFORMATION
2	REFER TO A103 FOR PARTITION TYPES AND DETAILS
3	REFER TO A104 AND A105 FOR FINISH INFORMATION
4	REFER TO A701 FOR WINDOW, DOOR, AND FRAME INFORMATION
5	PROVIDED CLOSURE STRIPS AT ALL JOINTS AND FIRESTOPPING AT GAPS BETWEEN TOP OF COOLER/FREEZER AND WALLS. VERIFY EXACT LOCATION WITH COOLER/FREEZER MANUFACTURER AND PROVIDE ALL FINAL CONNECTIONS.
6	ALL DIMENSIONS ARE SHOWN STUD TO STUD, UNLESS NOTED OTHERWISE.
7	SEE STRUCTURAL DRAWINGS FOR LOCATIONS OF ALL SHEAR WALLS AND SHEAR WALL CONSTRUCTION NOTES AND DETAILS.
8	COORDINATE ALL CLEAR DIMENSIONS IN AREAS OF WALK-IN COOLERS/FREEZERS WITH KITCHEN EQUIPMENT SUPPLIER AND INSTALLERS.
9	PROVIDE BLOCKING FOR ALL WALL MOUNTED OR RECESSED EQUIPMENT.

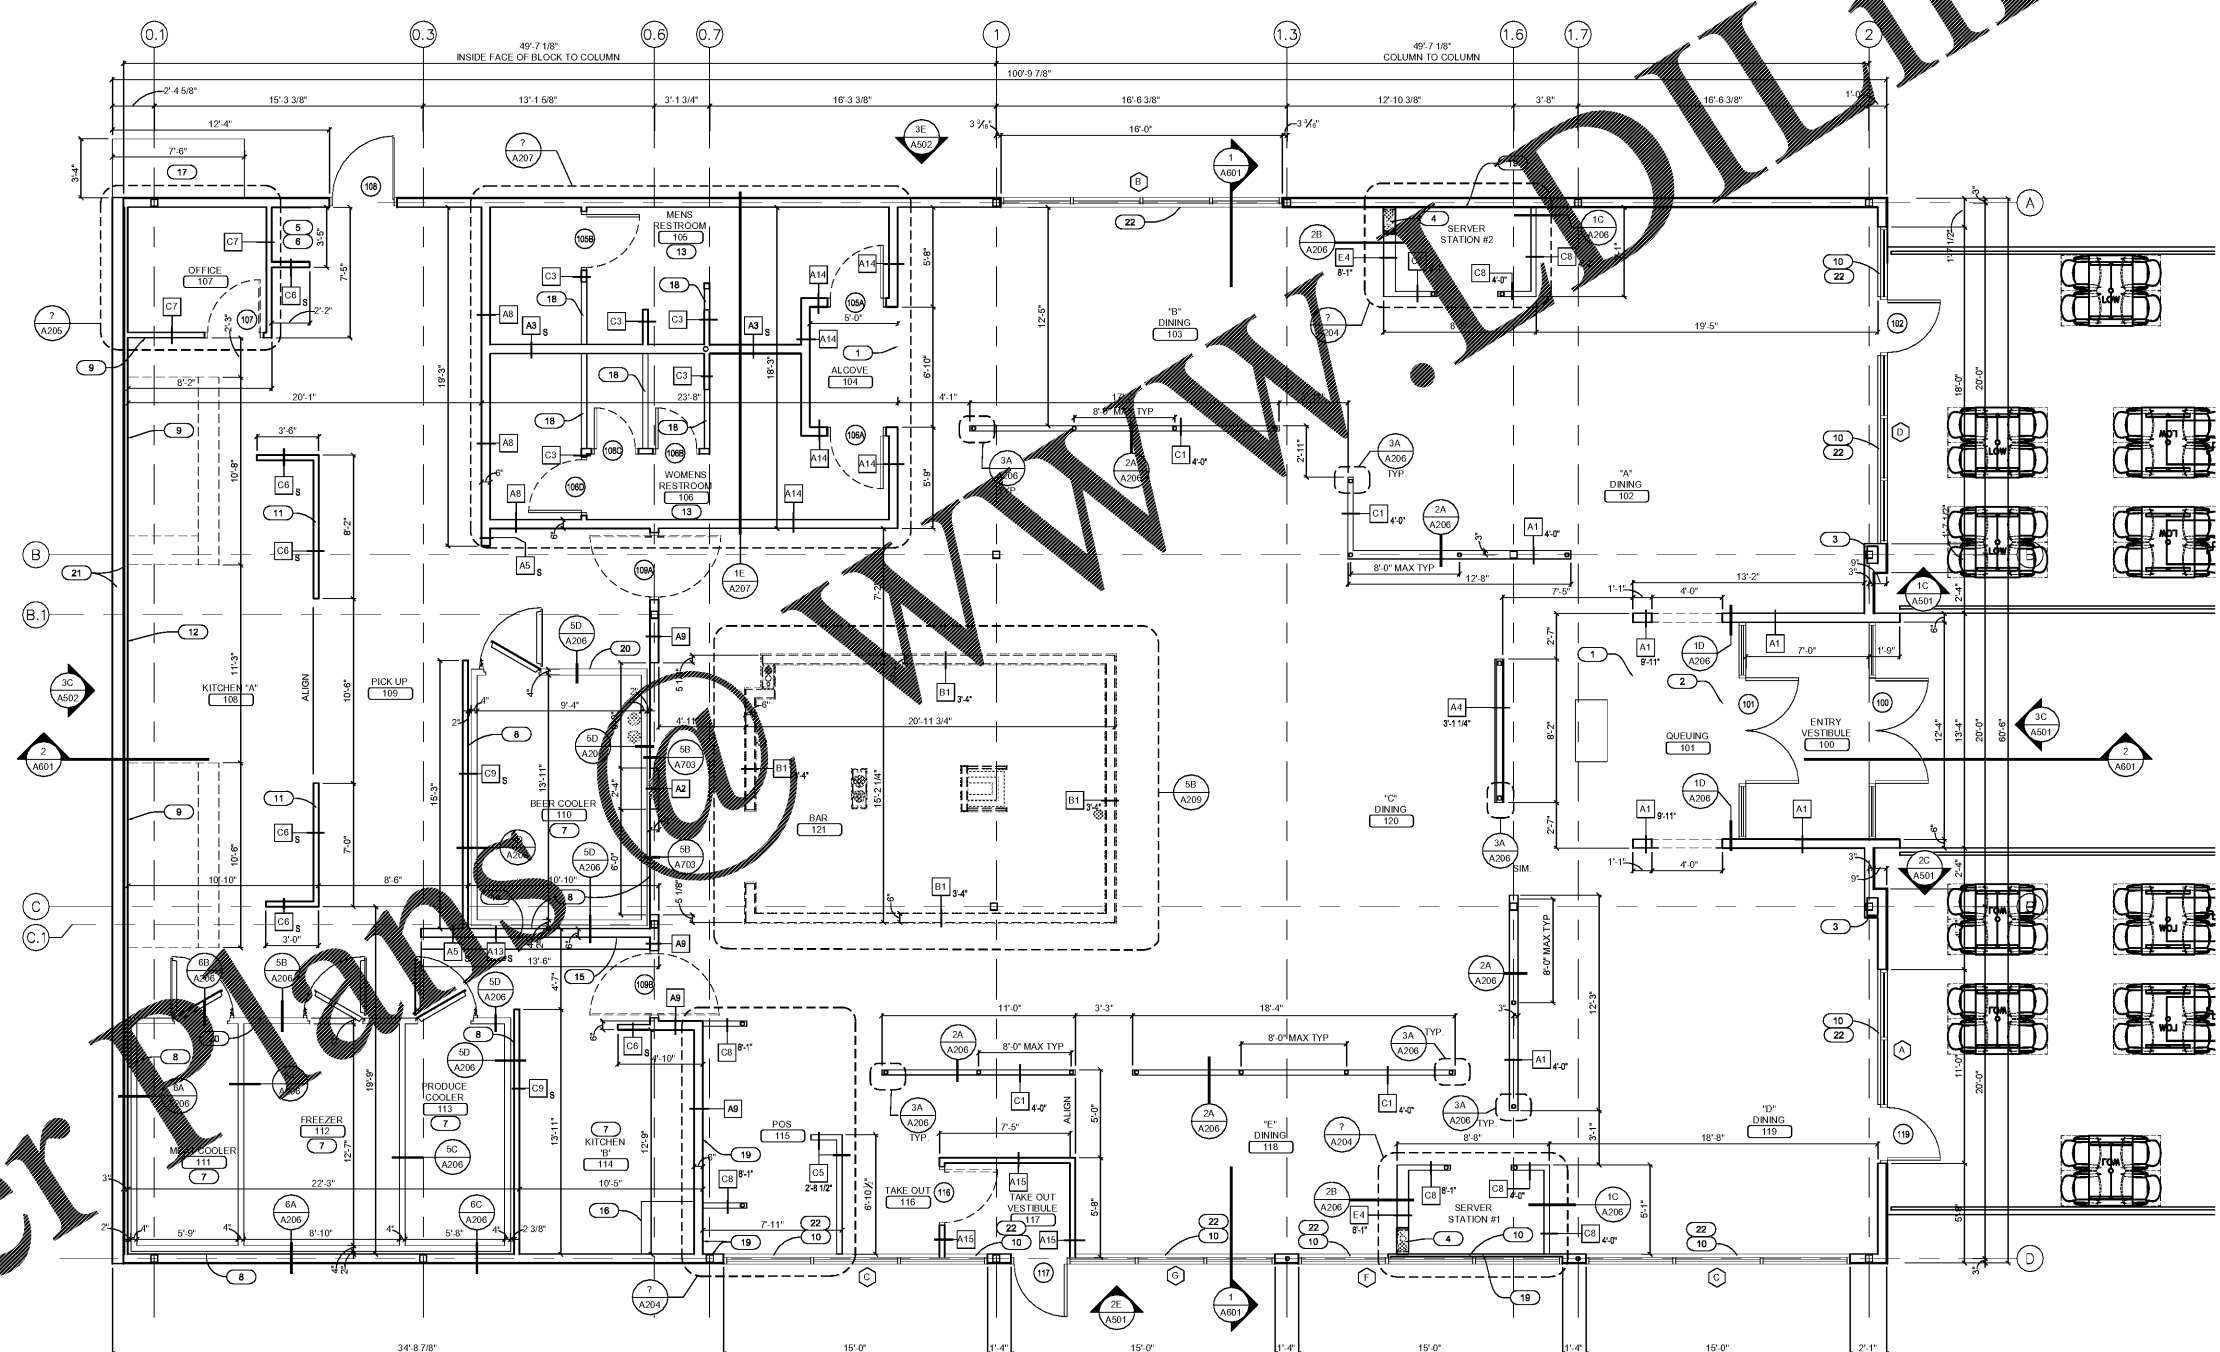

FRAMING PLAN
SCALE: 1/4"=1'-0"

CERTIFICATION

PRANGER GROUP INC.
PROJECT MANAGER

PROJECT NUMBER
5748

BUFFALO WILD WINGS
BIRMINGHAM
1416 4th AVENUE SOUTH,
BIRMINGHAM, AL 35233



NO	DESCRIPTION	DRAWING ISSUE	
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Drawing Title
FRAMING PLAN

A102

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