
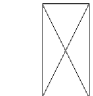
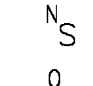



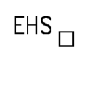
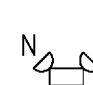







**ELECTRICAL LEGEND**


-  PROVIDE NEW LAY-IN FLUORESCENT LIGHT FIXTURE.
-  EXISTING LAY-IN FLUORESCENT LIGHT FIXTURE. RE-INSTALL SALVAGED FIXTURES IN NEW CEILING GRID IN CLASSROOM 815. PROVIDE NEW BULBS WHERE EXISTING ARE NOT WORKING.
-  PROVIDE NEW SINGLE POLE SWITCH.
-  PROVIDE NEW WALL MOUNTED PASSIVE INFRARED AND MICRO-PHONIC OCCUPANCY SENSOR EQUAL TO SENSOR SWITCH MODEL WSD P10. TIME DELAY 10 MINUTES FOR ON/OFF.
-  PROVIDE NEW CEILING MOUNTED PASSIVE INFRARED AND MICRO-PHONIC OCCUPANCY SENSOR EQUAL TO SENSOR SWITCH MODEL CM P10. TIME DELAYS 10 MINUTES FOR ON/OFF.
-  EXISTING FIRE ALARM HORN/STROBE TO REMAIN U.O.N.  
CONTRACTOR SHALL SYNCHRONIZE MULTIPLE DEVICES AS REQUIRED, NOW LOCATED IN THE SAME ROOM.
-  PROVIDE NEW EXIT SIGN FIXTURE WITH EMERGENCY LIGHTING.
-  EXISTING SMOKE DETECTOR FIXTURE TO REMAIN. COORDINATE WITH CEILING DEMOLITION AND RE-INSTALLATION IN NEW CEILING IN CLASSROOM 815.
-  PROVIDE NEW DUPLEX RECEPTACLE.

LIGHTING FIXTURE SCHEDULE										
SYMBOL	MANUFACTURER	CATALOG NUMBER	LAMP DATA		VOLTS	BALLAST DATA		INPUT WATTS	MOUNTING	REMARKS
			NO.	TYPE		NO.	TYPE			
	DAYBRITE	(MATCH EXISTING)		F32WT8	120	1	ELECTRONIC	64	LAY-IN	GENERAL DUTY 2'x4' LAY-IN FLUORESCENT FIXTURE WITH 0.125" THICK ACRYLIC LENS.
	LITHONIA	ECR LED M6	-	LED	-	-	-	4	WALL	EXIT/EMERGENCY LIGHT WITH BATTERY BACKUP
	LITHONIA	ELA LED M12	-	LED	-	-	-	2	WALL	REMOTE HEAD EMERGENCY LIGHT WITH BATTERY BACKUP

NOTES:  
1. EXTEND EXISTING CIRCUITS AS REQUIRED FOR NEW POWER/LIGHTING PLANS.

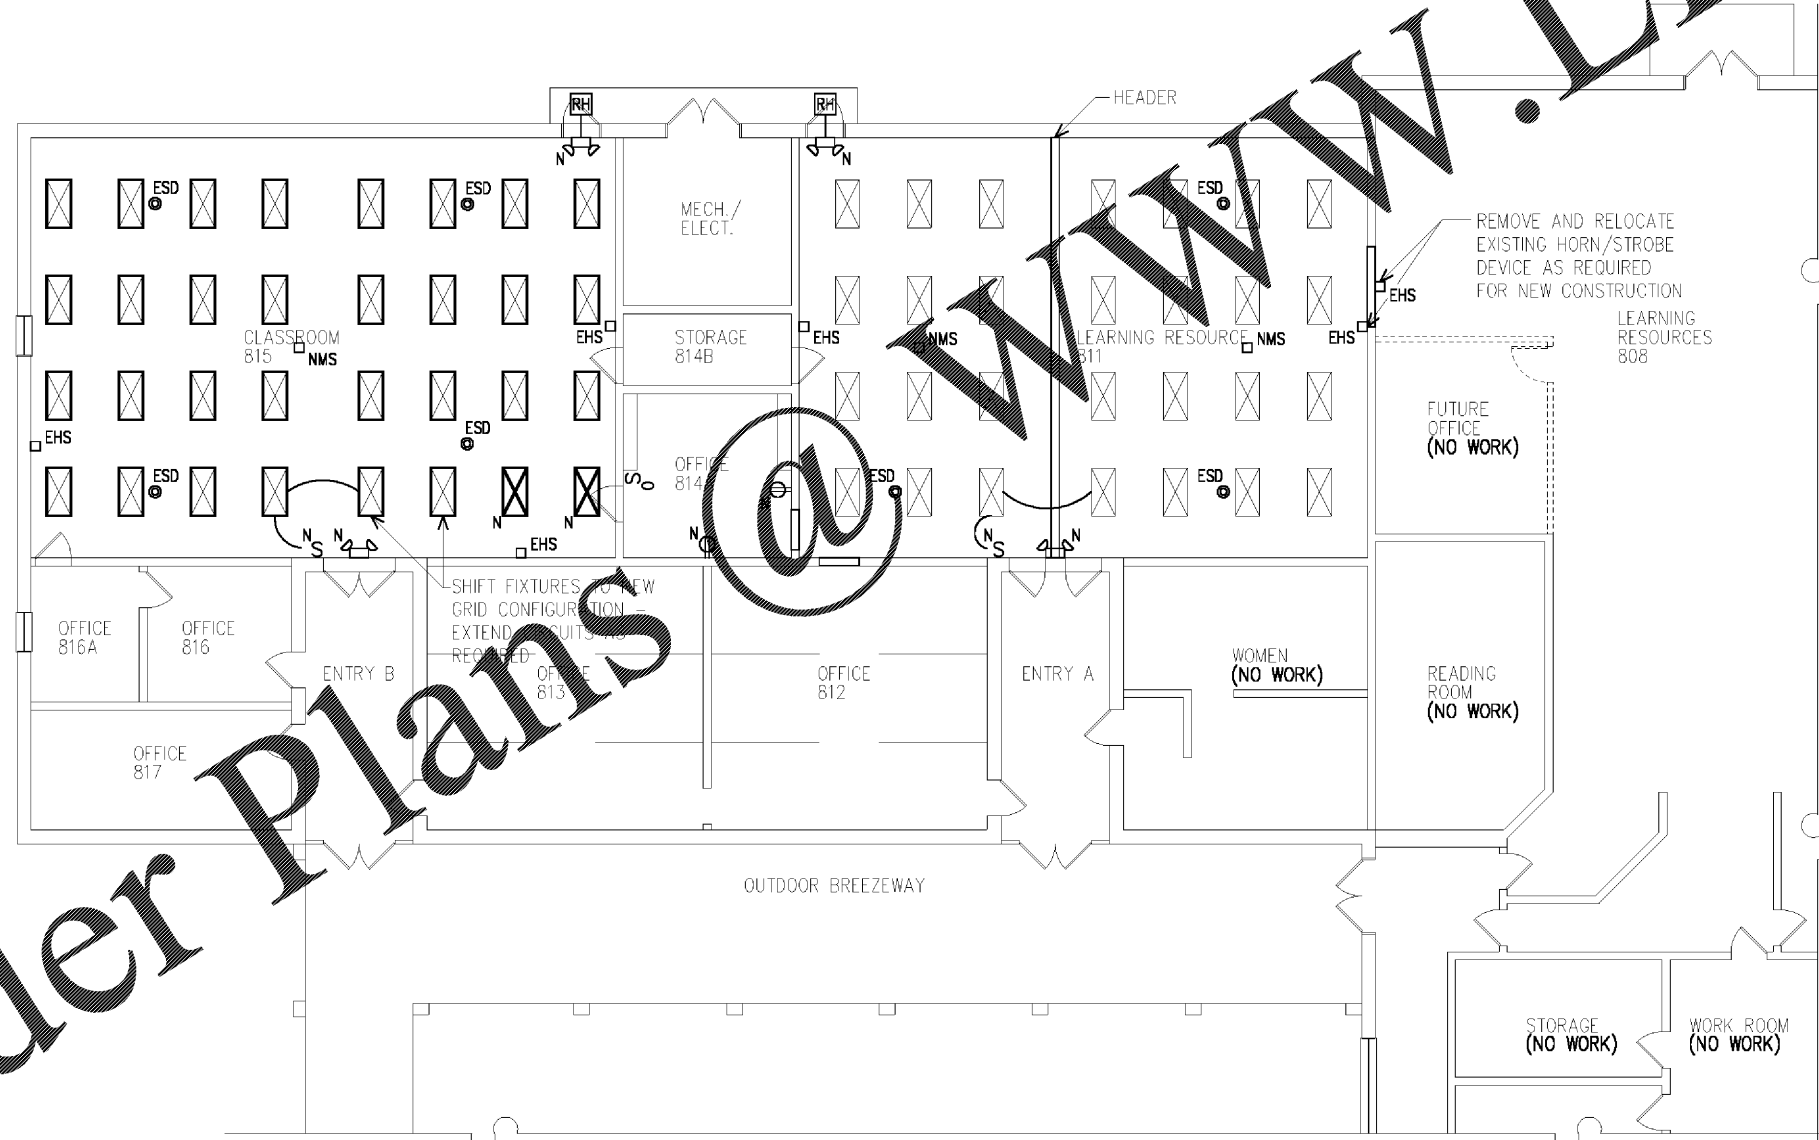

**1 ELECTRICAL REVISED PLAN - BUILDING #800**  
SCALE 1/16" = 1'-0"

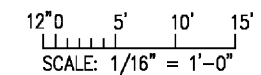

**STOGNER ARCHITECTURE, PA**  
ARCHITECTURE - CONSTRUCTION MANAGEMENT - DESIGN BUILD  
615 East Broad Avenue, Rockingham, North Carolina, 28379  
Phone 910-895-6874 Fax 910-895-1111

---

**NORTHEASTERN TECHNICAL COLLEGE**  
**BUILDING #800 RENOVATION**  
CHERAW SOUTH CAROLINA

---

ELECTRICAL REVISED PLAN; BUILDING #800

4420B \ E2.0.oec

COMM. NO.: 4420B

DRAWN BY: FJF

CHECKED BY: AWS

DATE: JAN. 19, 2018

SHEET NO.  
**E2.0**