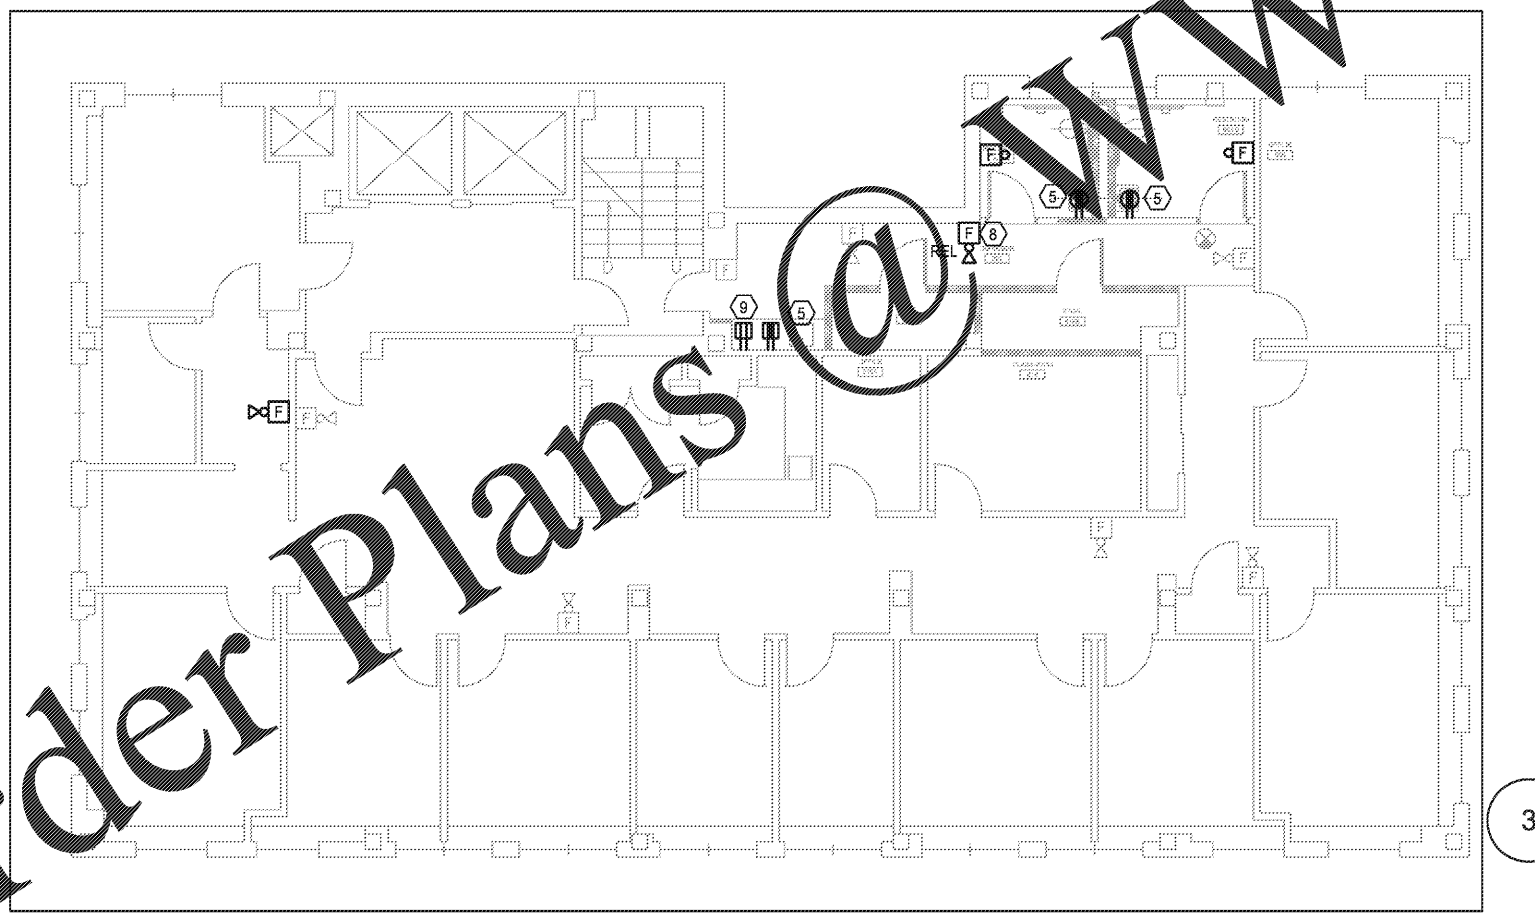


1 **ELECTRICAL DEMO PLAN - 8TH FL**  
SCALE: 1/8"=1'-0"



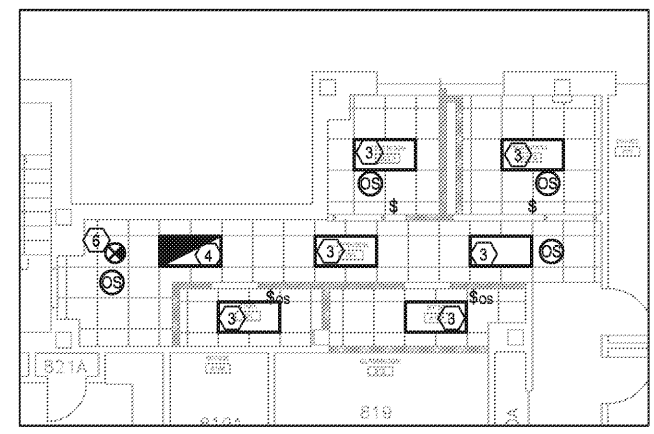
2 **ELECTRICAL NEW PLAN - 8TH FL**  
SCALE: 1/8"=1'-0"

**KEY NOTES:**

- 1 REMOVE LIGHT FIXTURES AND CONTROLS SERVING SPACE. EXISTING LIGHTING CIRCUIT TO REMAIN AND BE RE-USED WITH NEW LIGHT FIXTURE. REFER TO 3/E1.7 FOR NEW LIGHTING LAYOUT.
- 2 REMOVE EXISTING ELECTRICAL DEVICE. EXISTING CIRCUIT TO REMAIN AND BE RE-USED WITH NEW ELECTRICAL DEVICE. REFER TO 2/E1.7 FOR NEW RECEPTACLE LOCATION.
- 3 NEW LIGHT FIXTURE, MANUFACTURED BY COOPER, CAT# 24EN-LD2-45-UNV-L840-CD1-U. CONTRACTOR TO UTILIZE EXISTING LIGHTING CIRCUIT SERVING SPACE.
- 4 NEW EMERGENCY LIGHT FIXTURE, MANUFACTURED BY COOPER, CAT# 24EN-LD2-45-UNV-L840-CD1-U-EL. CONTRACTOR TO UTILIZE EXISTING LIGHTING CIRCUIT SERVING SPACE. PROVIDE BATTERY BACKUP TO MATCH SUPPLY VOLTAGE.
- 5 NEW 120VAC, 20A, 1-PHASE DUPLEX RECEPTACLE. CONTRACTOR TO UTILIZE EXISTING CIRCUIT SERVING SPACE.
- 6 NEW EXIT LIGHT, MANUFACTURED BY LUMINIA, CAT#LRP-W-1-PANELN. CONTRACTOR TO UTILIZE EXISTING LIGHTING CIRCUIT SERVING SPACE. PROVIDE BATTERY BACKUP.
- 7 RELOCATE FIRE ALARM DEVICE. REFER TO 2/E1.7 FOR NEW LOCATION.
- 8 RELOCATED FIRE ALARM DEVICE. REFER TO 1/E1.7 FOR PREVIOUS LOCATION.
- 9 REFRIGERATOR TO CONNECT TO EXISTING 20A/1P CIRCUIT BREAKER IN EXISTING SPACE IN NEARBY PANEL. CONFIRM AVAILABILITY OF CIRCUITS AND NOTE ANY DISCREPANCIES ON THE AS-BUILT SET.

**GENERAL NOTES:**

1. ELECTRICAL DEVICES SHOWN IN LIGHT PENWEIGHT ARE EXISTING TO REMAIN. ELECTRICAL DEVICES SHOWN IN HEAVY PENWEIGHT ARE DEMO OR NEW UNLESS OTHERWISE NOTED.
2. EXISTING CIRCUITS SERVING MECHANICAL EQUIPMENT ARE TO REMAIN UNLESS OTHERWISE NOTED.
3. EMERGENCY/EXIT/EGRESS LIGHTING FIXTURES ARE SPECIFIED WITH BATTERY BACKUP. CONNECT TRICKLE CHARGE INPUTS TO UNSWITCHED CIRCUIT CONDUCTORS OF LIGHTING CIRCUITS SERVING THE NORMAL LIGHTING IN THE SAME ROOM.
4. OCCUPANCY SENSORS SHALL PROVIDE 100% COVERAGE PER MANUFACTURERS RECOMMENDATIONS.
5. CONNECT NEW FIRE ALARM DEVICES TO EXISTING BUILDING FIRE ALARM SYSTEM. NEW FIRE ALARM DEVICES SHALL BE MANUFACTURED BY SIMPLEX. FIELD VERIFY EXISTING SYSTEM LOCATION AND THAT IT IS ADEQUATE FOR NEW FIRE ALARM DEVICES.

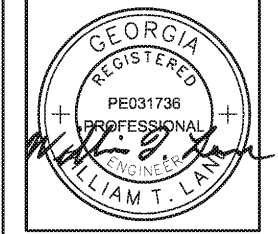


3 **ELECTRICAL RCP PLAN - 8TH FL**  
SCALE: 1/8"=1'-0"

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**ELECTRICAL SYSTEMS - HAAS HOWELL BLDG**

DRAWING NUMBER

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