


A
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T

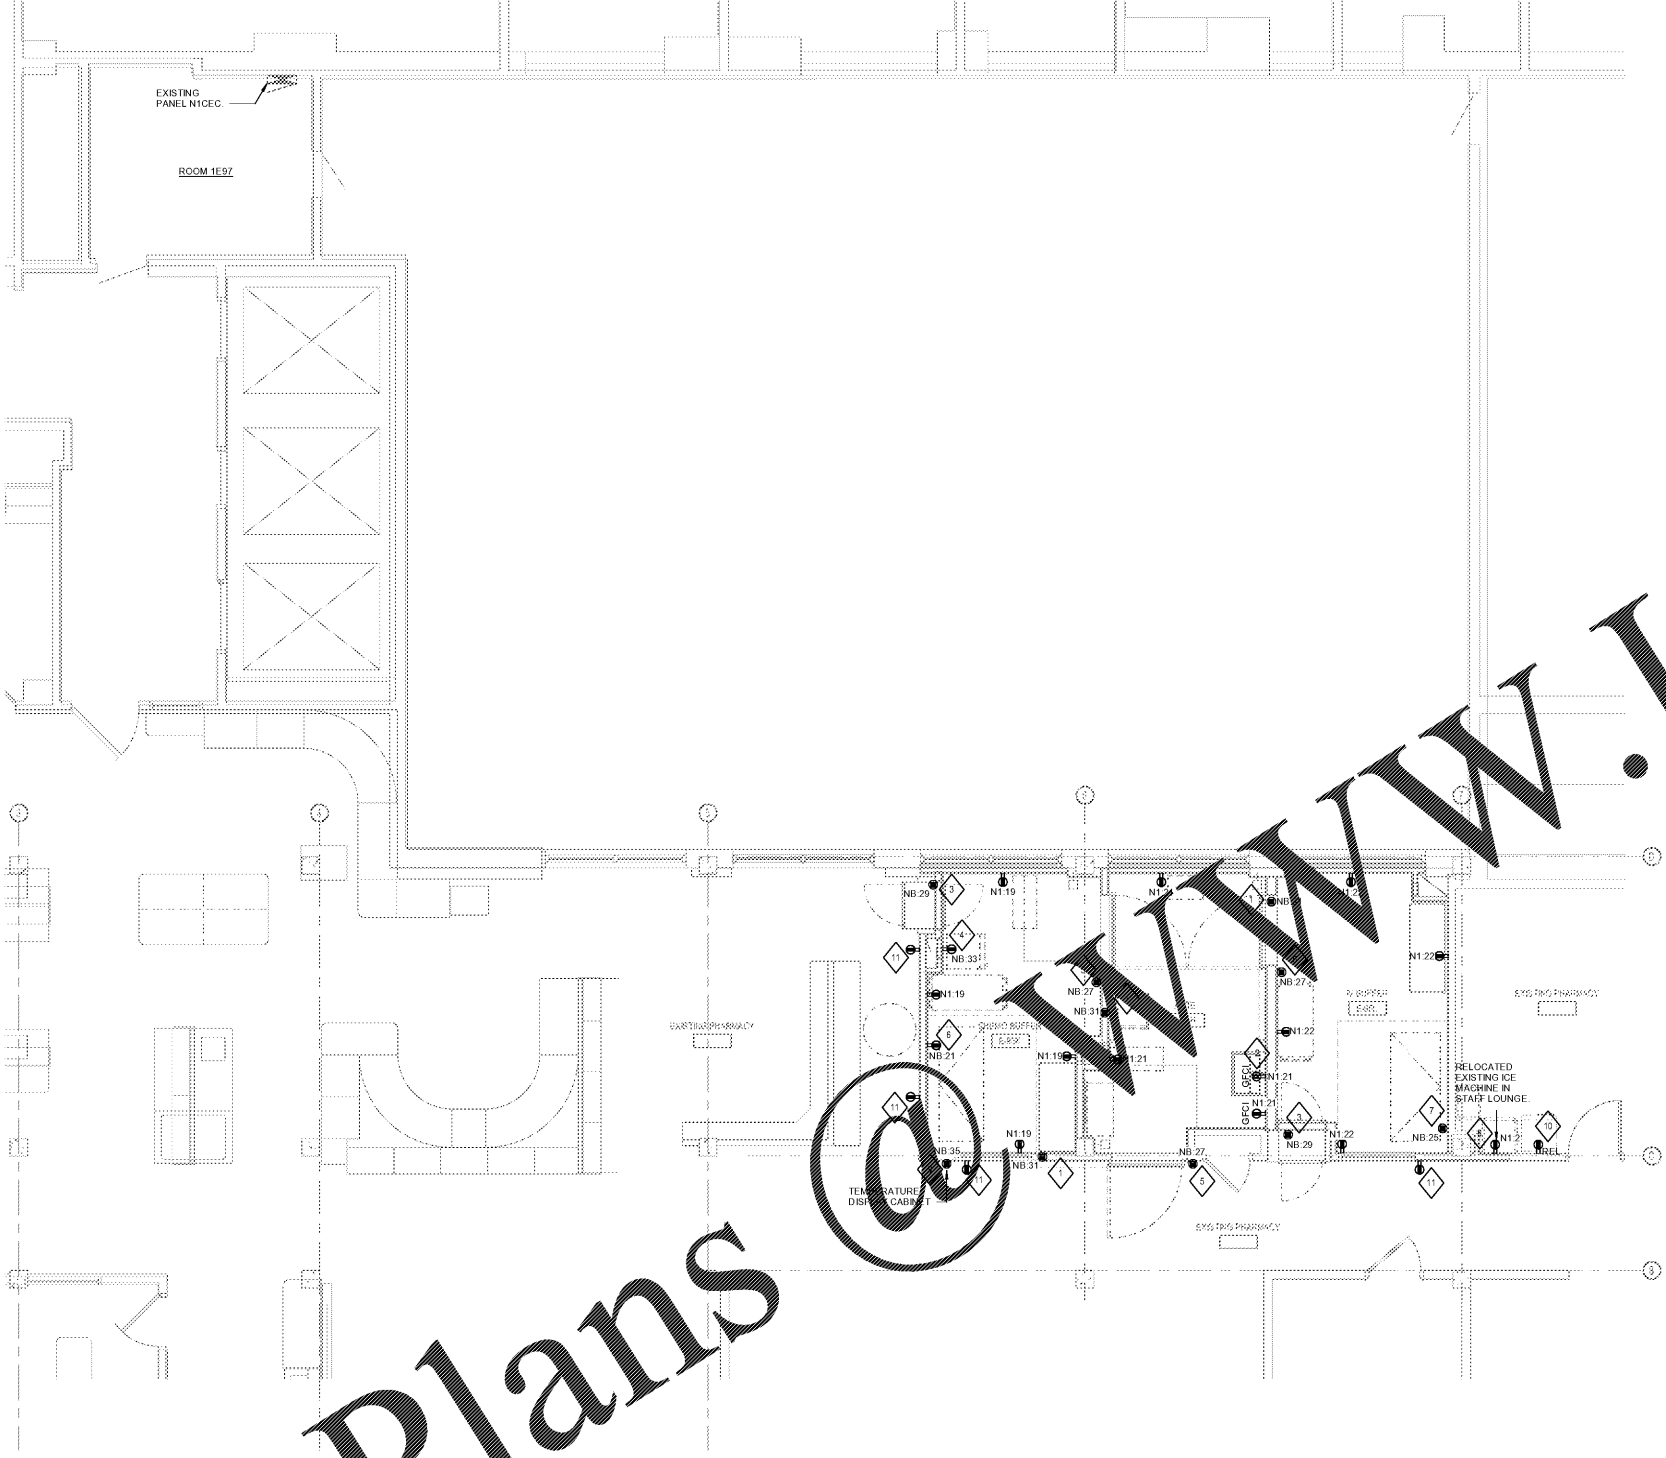

GENERAL NOTES

1. FOR EXACT LOCATION AND FINISHED SURFACE CONDITIONS OF CEILING, WALL, AND FLOOR MOUNTED DEVICES, REFER TO ARCHITECTURAL DRAWINGS, ELEVATIONS AND REFLECTED CEILING PLANS.
2. ALL DEVICES SHALL BE INSTALLED IN EXISTING AND NEW WALLS. CONTRACTOR SHALL FISH EXISTING WALLS OR CUT AND REPAIR AS REQUIRED.
3. ADJACENT POWER AND DATA DEVICES SHALL BE SPACED NO MORE THAN 4" APART. PROVIDE JUNCTION BOX MOUNTING BRACKET BETWEEN STUDS AS NEEDED.
4. WORK SHALL NOT INTERFERE WITH OPERATION OF ROBOTICS AREA OF PHARMACY.
5. CIRCUITS WITH DESIGNATION 'NB' SHALL BE FED FROM EXISTING PANEL 'NBCEC' LOCATED IN THE BASEMENT. SEE SHEET E206 FOR LOCATION OF 'NBCEC' IN BASEMENT. CIRCUITS WITH DESIGNATION 'NT' SHALL BE FED FROM EXISTING PANEL 'N1CEC' IN ROOM 1E97.
6. SEE SHEET E801 FOR PLENUM ELECTRICAL BOX FOR CLEANROOM DETAIL.

SHEET KEYNOTES

1. POWER CONNECTION TO SLIDE DOOR SYSTEM.
2. POWER CONNECTION TO SINK SENSOR. COORDINATE HEIGHT WITH ARCHITECT.
3. POWER CONNECTION TO HEPA PASS THRU. COORDINATE HEIGHT WITH ARCHITECT.
4. POWER CONNECTION TO REFRIGERATOR. PROVIDE 120V 20A/1PH DEDICATED CIRCUIT.
5. POWER CONNECTION TO SUPPRESSURE RO. PROVIDE 120V 20A/1PH DEDICATED CIRCUIT.
6. POWER CONNECTION TO LOGICAL SAFETY CABINET. PROVIDE 120V 20A/1PH DEDICATED CIRCUIT.
7. POWER CONNECTION TO LAMINAR FLOW WORKBENCH. PROVIDE 120V 30A/1PH DEDICATED CIRCUIT. PROVIDE NEW 30A CIRCUIT BREAKER AND REPLACE EXISTING CIRCUIT BREAKER IN EXISTING PANEL.
8. PROVIDE RECEPTACLE FOR RELOCATED ICE MACHINE. PROVIDE 120V 20A/1PH DEDICATED CIRCUIT.
9. POWER CONNECTION TO TEMPERATURE DISPLAY CABINET. PROVIDE 120V 20A/1PH DEDICATED CIRCUIT. COORDINATE LOCATION WITH MC.
10. RELOCATE EXISTING RECEPTACLE AND CIRCUIT FOR RELOCATED REFRIGERATOR. SEE SHEET E101 FOR EXISTING RECEPTACLE LOCATION.
11. PROVIDE AND CIRCUIT HALLWAY RECEPTACLES TO SAME CIRCUIT ON EXISTING PANEL 'N1CEC' IN NEXT AVAILABLE UNUSED CIRCUIT BREAKER AFTER FIELD VERIFICATION OF EXISTING AVAILABLE CIRCUITS.

1 ELECTRICAL POWER PLAN - FIRST FLOOR
1/4" = 1'-0"

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 Order Plans

Revisions:	Date:

CONSULTANT

Consultant:
AEI Affiliated Engineers
 5802 Research Park Boulevard
 Madison, WI 53719
 608.238.2616
 aeieing.com

ARCHITECT/ENGINEER OF RECORD

A/E:
LA LACHIN Architects, apc
 Architecture, Planning, Project Management
 5190 Canal Boulevard, Suite 201
 New Orleans, LA 70124
 (504)835-8013

STAMP

Office of Construction and Facilities Management

VA U.S. Department of Veterans Affairs

Drawing Title
ELECTRICAL POWER FLOOR PLAN - FIRST FLOOR

Approved: _____

Phase
CONSTRUCTION DOCUMENTS

Project Title
RENOVATE PHARMACY CLEAN ROOM (USP 797)

Location
 510 E. Stoner Ave. Shreveport, LA 71101

Issue Date
 10/05/2017

Checked
 RRK

Drawn
 KJS

Project Number
 667-17-108

Building Number
 1

Drawing Number
E201