


Order Plans @

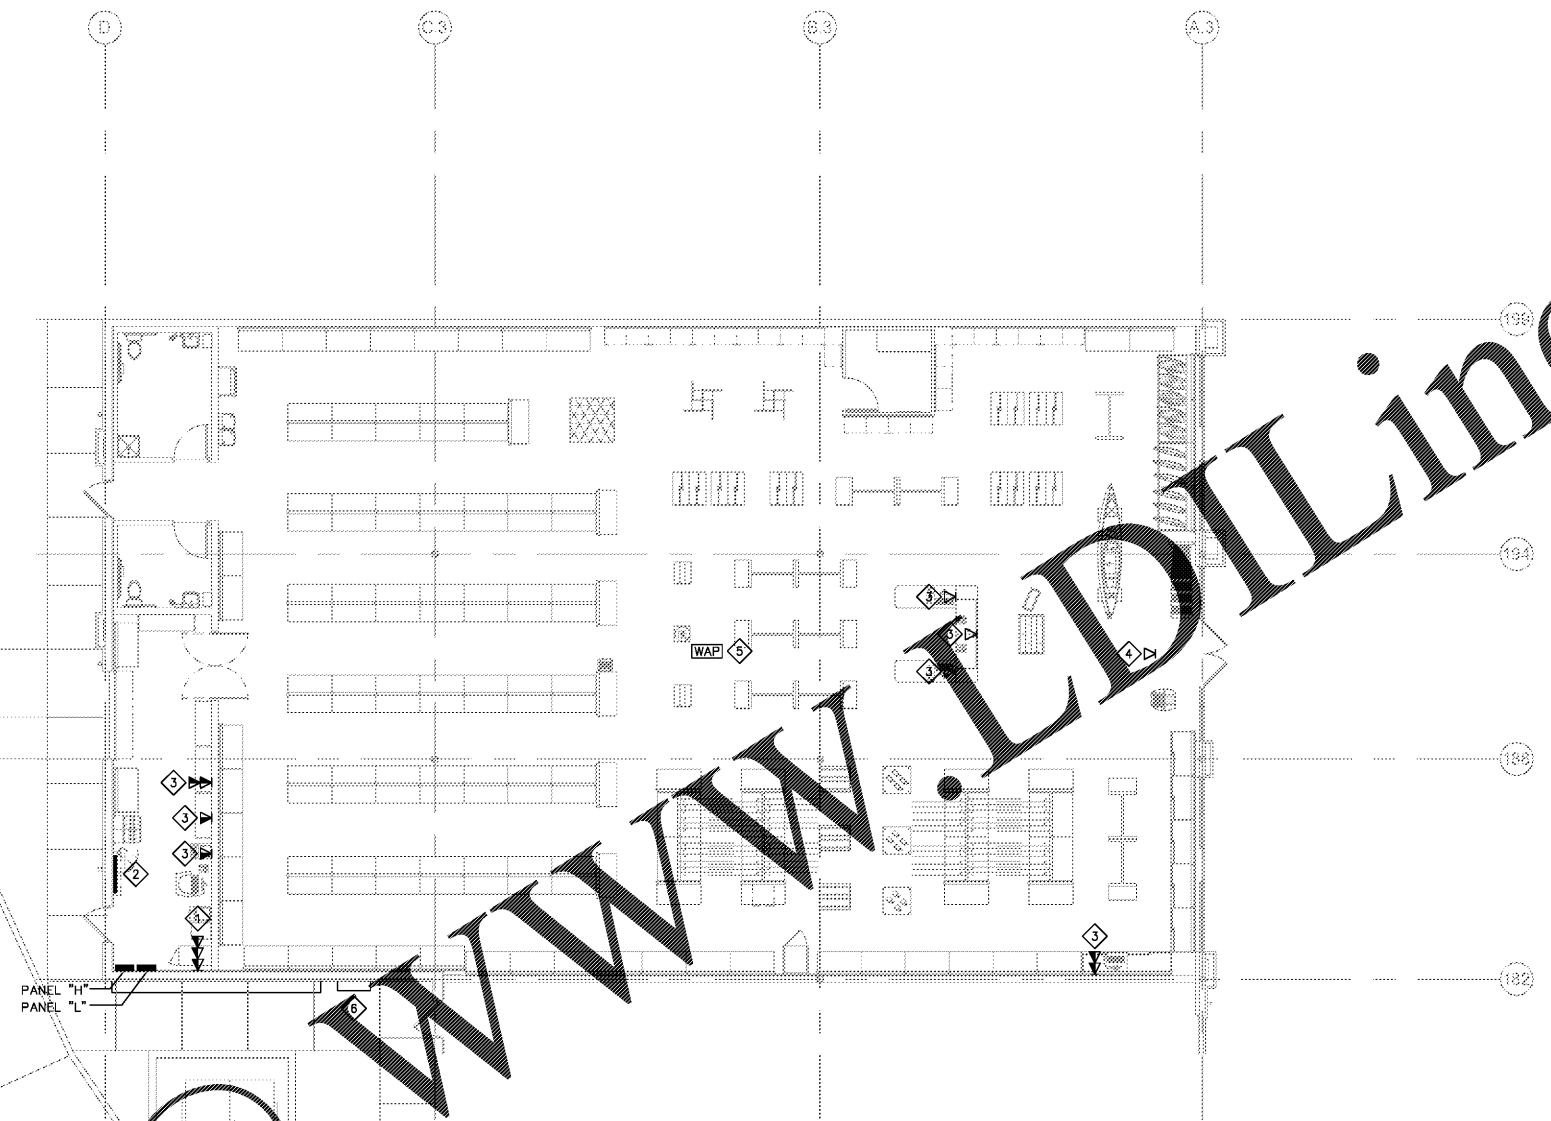

1 LOW-VOLTAGE SYSTEMS PLAN  
1/8" = 1'-0"

**GENERAL NOTES**

- A. CONTRACTOR SHALL COMPLETELY REMOVE ALL EQUIPMENT, PANELBOARDS, DEVICES, FIXTURES, WIRING, CONDUIT, ETC. AND ALL ASSOCIATED SUPPORTS, BRACING, PADS, ETC. NOT BEING REUSED OR SHOWN TO REMAIN WHETHER IN THE DEMISED SPACE, ON THE ROOF OR OTHERWISE LOCATED OUTSIDE OF THE DEMISED SPACE. DO NOT ABANDON IN PLACE.
- B. ALL 120 VOLT BRANCH CIRCUITS IN EXCESS OF 75' SHALL HAVE CONDUCTOR SIZE INCREASED A MINIMUM OF 1 CONDUCTOR SIZE. INSTALLING CONTRACTOR SHALL DETERMINE ACTUAL CONDUCTOR SIZE TO BE INSTALLED TO ADHERE TO VOLTAGE DROP REQUIREMENTS.
- C. PROVIDE A NEUTRAL CONDUCTOR FOR EACH BRANCH CIRCUIT. NEUTRAL SHARING IS NOT ALLOWED. PROVIDE MULTI-BREAKER AS ALTERNATE PER NEC. REQUIREMENT.
- D. ELECTRICAL SYSTEM SHALL BE GROUNDED AND BONDED PER NEC REQUIREMENTS AND AUTHORITY HAVING JURISDICTION.
- E. ALL DEVICES SHALL BE MOUNTED VERTICALLY AT 18" A.F.F. TO CENTER OF DEVICE, UNLESS NOTED OTHERWISE.
- F. ALL FLOOR BOXES TO BE OMNIBOX, FLUSH WITH FINISHED FLOOR, WITH BRASS RING FLUSH WITH FINISH FLOOR.
- G. ALL MATERIALS AND WORKMANSHIP SHALL CONFORM TO BASE BUILDING SPECIFICATION, LOCAL CODES AND ORDINANCES, AND INDUSTRY STANDARDS.
- H. ALL ELECTRICAL FACE PLATES IN SALES AREA SHALL BE WHITE.
- I. PROVIDE COMPLETE, TYPED CIRCUIT DIRECTORY CARDS FOR EVERY PANEL IN TENANT LEASE SPACE.
- J. SEE ARCHITECTURAL PLANS FOR DEMOLITION SCOPE.
- K. CONDUITS INSTALLED IN TRENCHES BELOW CONCRETE MUST BE INSPECTED PRIOR TO BACK FILL.
- L. COORDINATE ALL DATA LOCATIONS AS THEY CORRESPOND TO RECEPTACLE LOCATIONS. SEE SHEET E200 FOR ADDITIONAL INFORMATION.
- M. REFER TO DATA DRAWINGS T401, T501, T502, AND T701 FOR ADDITIONAL INFORMATION.

**KEY NOTES**

- 1 LOCATION OF NETWORK CABINET. SEE DETAILS ON SHEETS E302 FOR ADDITIONAL INFORMATION.
- 2 LOCATION OF NEW PHONE BOARD FOR TELEPHONE/DATA SERVICE.
- 3 LOCATION OF DATA JUNCTION BOX.
- 4 DATA RECEPTACLE IN CEILING.
- 5 LOCATION OF WIRELESS ACCESS POINT.
- 6 LOCATION OF BUILDING DATA DATA SERVICE. EXTEND EXISTING 1" CONDUIT FROM REAR WALL OF PREMISES TO LOCATION OF NEW PHONEBOARD. FIELD VERIFY LOCATION OF EXISTING 1" CONDUIT.

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STORE #TBD

commission number R17-2777.003

WM 75%	07/07/2017
LL Final	
Permit	07/24/2017
Bidding	10/02/2017

drawing title  
TECHNOLOGY FLOOR PLAN

sheet number  
T201