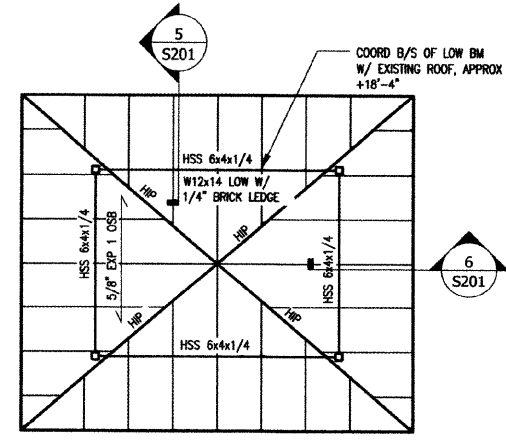


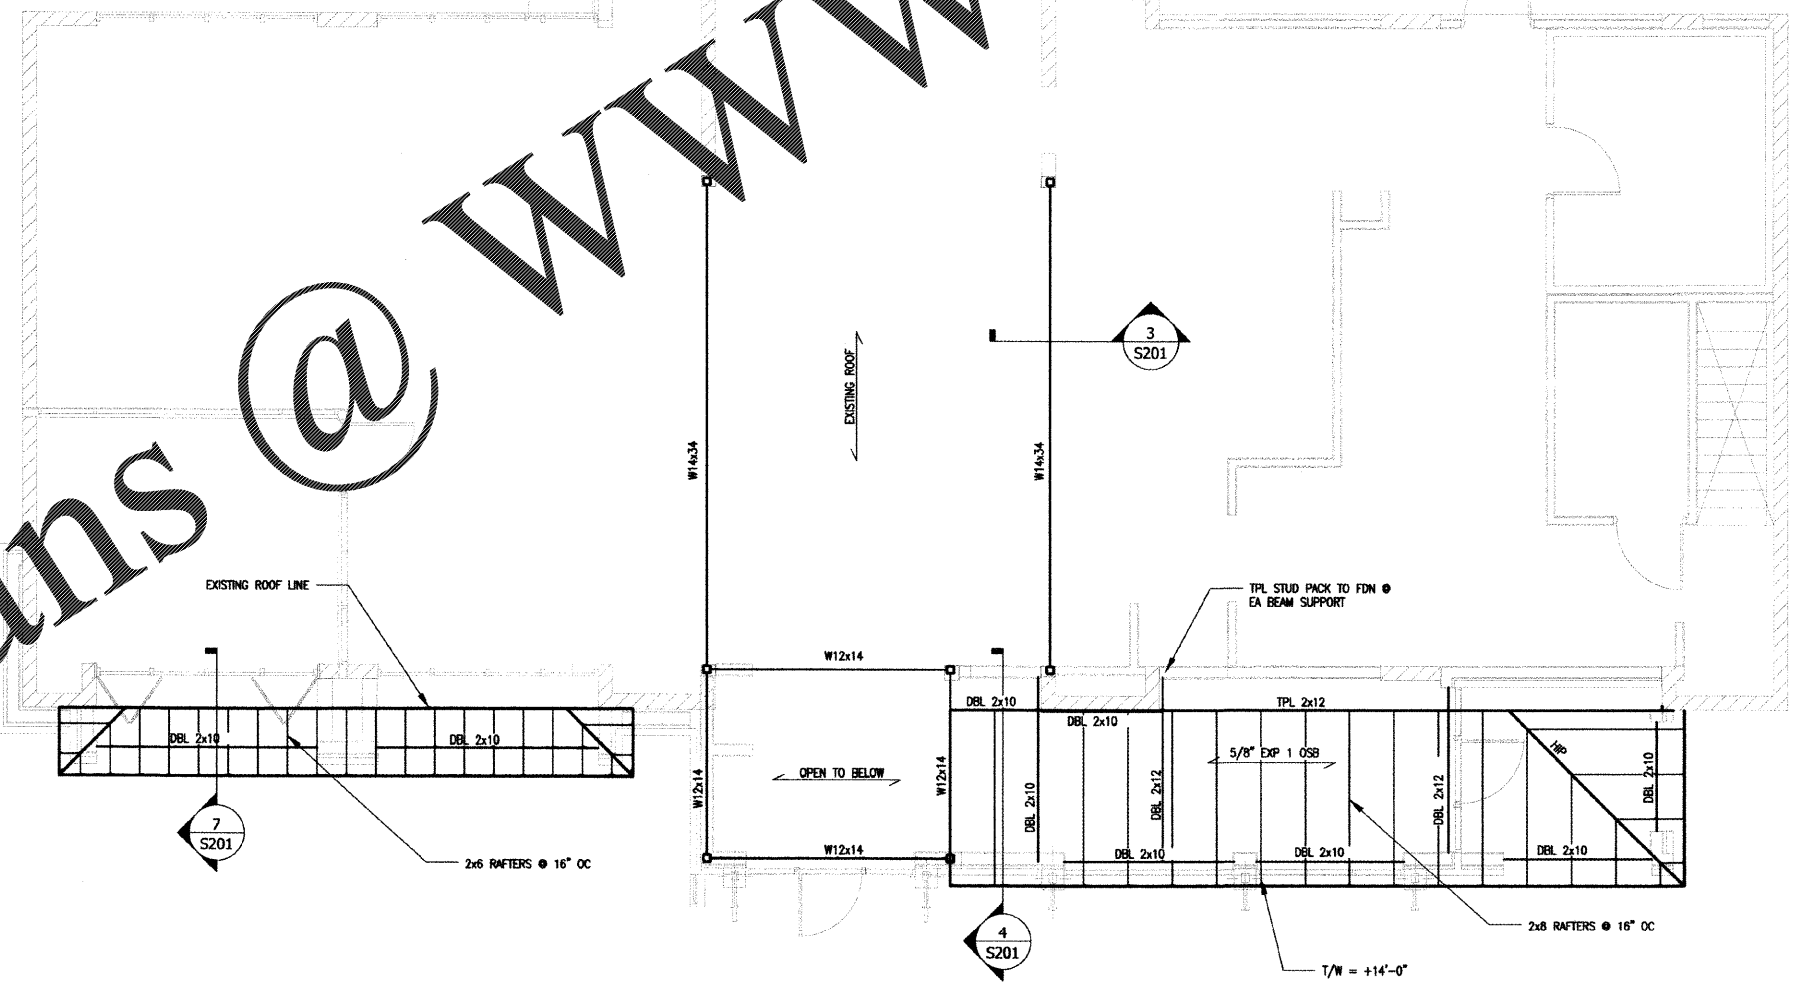
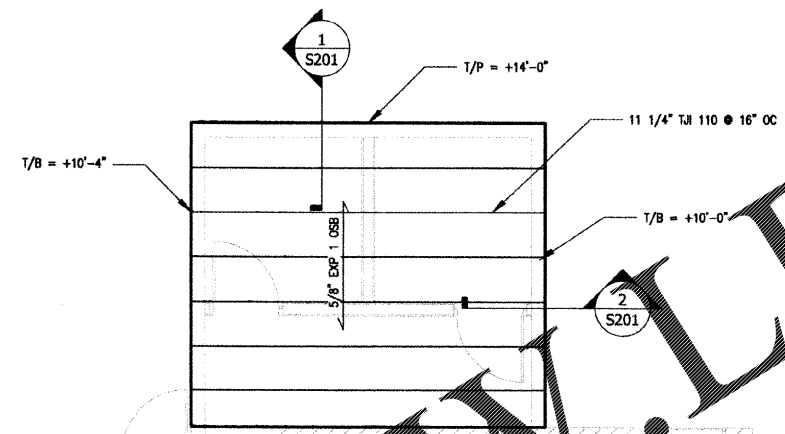
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SEALS



TOWER ROOF FRAMING PLAN

1/4" = 1'-0"
 ROOF TRUSS BEARING ELEVATION = +24'-0"
 TOP OF STEEL ELEVATION = +23'-10 1/2" (UNO)
 T/B DENOTES TRUSS BRG ELEV
 T/S DENOTES TOP OF STEEL ELEV
 B/S DENOTES BOTTOM OF STEEL ELEV
 ROOF TRUSSES @ 24" OC MAX (UNO)
 VERIFY ALL ELEV WITH ARCH



ROOF FRAMING PLAN

1/4" = 1'-0"
 TOP OF STEEL ELEVATION = +24'-2" (UNO)
 TOP OF WALL/PARAPET ELEVATION = +14'-0" (UNO)
 T/B DENOTES TRUSS BRG ELEV
 T/S DENOTES TOP OF STEEL ELEV
 B/S DENOTES BOTTOM OF STEEL ELEV
 P DENOTES TOP OF PARAPET ELEV
 ROOF TRUSSES @ 24" OC MAX (UNO)
 VERIFY ALL ELEV WITH ARCH

DIABLOS

CITY OF AUGUSTA, GEORGIA

REV	DATE	DESCRIPTION	APP

ISSUE DATE: MAR 28, 2016
 DESIGNED BY: JES DRAWN BY: JES
 CHECKED BY: SUBMITTED BY: JES

STRUCTURAL

ROOF
 FRAMING
 PLANS

S102

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