


**2 ENLARGED PLAN**  
A1 SCALE: 1/4"=1'-0"

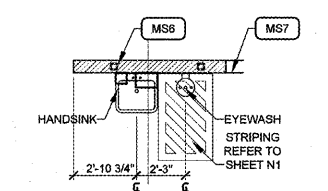

**5 ENLARGED PLAN**  
A1 SCALE: 1/4"=1'-0"

### STANDARD WALL TYPES

NOTES:  
1. SOME WALL TYPES MAY NOT BE USED. REFER TO PLANS  
2. REFER TO STRUCTURAL DRAWINGS FOR STUD GAUGES AND ADDITIONAL FRAMING INFORMATION.

CMU1	8" HIGH REINFORCED CONCRETE MASONRY UNIT. SMOOTH BOTH SIDES. REFER TO ELEVATIONS.
CMU2	4" HIGH, 8" DEEP REINFORCED QUIK BRICK. ALL DECORATIVE SURFACES SHOULD FACE TO EXTERIOR SIDE ONLY. REFER TO ELEVATIONS.
CMU3	4" HIGH, 12" DEEP REINFORCED QUIK BRICK. ALL DECORATIVE SURFACES SHOULD FACE TO EXTERIOR SIDE ONLY. REFER TO ELEVATIONS.
FRP	FRP BOARD SHINE EDGE TO EDGE. REFER TO INTERIOR ELEVATIONS ON SHEET A1 FOR HEIGHTS A.F.F.
MS1	3 5/8" METAL STUDS AT 16" O.C. WITH 5/8" GYPSUM BOARD BOTH SIDES. EXTEND PARTITION TO DECK (TYPICAL U.N.O.). USE MOISTURE RESISTANT GYPSUM BOARD ON INTERIOR SIDE OF TOILET AND MOP BASIN AREAS.
MS2	3 5/8" METAL STUDS AT 16" O.C. WITH 5/8" GYPSUM BOARD BOTH SIDES WITH SOUND ATTENUATION BLANKETS BETWEEN. EXTEND PARTITION TO DECK (TYPICAL U.N.O.). USE MOISTURE RESISTANT GYPSUM BOARD ON INTERIOR SIDE OF TOILET AND MOP BASIN AREAS AND BEHIND DRINKING FOUNTAINS.
MS3	1 1/2" 2" FURRING AT 24" O.C. (ON MASONRY WALL) WITH 5/8" GYPSUM BOARD. EXTEND 1 1/2" RIGID INSULATION TO DECK ABOVE. (TYPICAL U.N.O.) USE MOISTURE RESISTANT GYPSUM BOARD IN TOILET AND MOP SINK AREAS AND 6" METAL STUDS @ 16" O.C. IN PLUMBING WALLS.
MS4	3 5/8" METAL STUDS AT 16" O.C. WITH 1/2" PLYWOOD BOTH SIDES. PAINTED (TYPICAL UNLESS NOTED OTHERWISE).
MS5	6" METAL STUDS AT 16" O.C. WITH 5/8" GYPSUM BOARD BOTH SIDES WITH SOUND ATTENUATION BLANKETS BETWEEN. EXTEND PARTITION TO DECK (TYPICAL U.N.O.) AT SIM. CONDITION. EXTEND PARTITION 4" MIN. ABOVE CEILING. USE MOISTURE RESISTANT GYPSUM BOARD ON INTERIOR SIDE OF TOILET AND MOP BASIN AREAS.
MS6	6" METAL STUDS TO 8' A.F.F. AT 16" O.C., STEEL COLUMNS WITHIN WALL FOR SUPPORT WITH 1/2" PLYWOOD BOTH SIDES. PAINTED. REFER STRUCTURAL DRAWINGS FOR STEEL COLUMNS.
MS7	6" METAL STUDS TO 4' A.F.F. AT 16" O.C., STEEL COLUMNS WITHIN WALL FOR SUPPORT WITH 1/2" PLYWOOD BOTH SIDES. PAINTED. REFER STRUCTURAL DRAWINGS FOR STEEL COLUMNS.
MS8	3 5/8" METAL STUDS AT 16" O.C. WITH 5/8" GYPSUM BOARD BOTH SIDES. 3/4" PLYWOOD ATTACHED TO STUDS ON SHOP SIDE ONLY.


### ACCESSORIES

MARK	DESCRIPTION
A	42" GRAB BAR WITH WOOD BACKER, WITH 18" VERTICAL BAR AS REQUIRED.
B	36" GRAB BAR WITH WOOD BACKER
C	TOILET TISSUE DISPENSER
D	MIRROR - SEE ELEVATIONS FOR SIZE
E	PAPER TOWEL DISPENSER & DISPOSAL
F	SANITARY NAPKIN DISPOSAL UNIT
G	COAT HOOK
H	HANDICAP SIGN-MOUNT 5'-0" AFF TO CENTER: 8" EDGE TO JAMB EDGE.
I	BABY CHANGING STATION. SEE DETAIL 1/N1
J	6 HALF LOCKER UNIT QTY(2)(SECURE TO WALL)
K	WRITING SURFACE. SEE DETAIL 11/A7

NOTES:  
1. PROVIDE WOOD BLOCKING AS REQUIRED FOR MOUNTING ACCESSORIES  
2. ACCESSORY PACKAGE AVAILABLE FROM NATIONAL VENDOR.  
3. REFER TO SHEET N1 FOR MOUNTING HEIGHTS, LOCATIONS, ETC OR TOILET ROOM ACCESSORIES.

### GENERAL NOTES

- WALL DIMENSIONS ARE TO FINISH CLEAR DIMENSION. ALL MATERIALS MUST BE FIGURED INTO THE LAYOUT OF THE FRAMING.
- MASONRY OPENING SHALL BE COORDINATED WITH WINDOW OR DOOR MANUFACTURERS REQUIREMENTS.
- PLUMBING ROUGH INS ARE CRITICAL FOR ADA CLEARANCES. VERIFY ALL PLUMBING ROUGH INS PRIOR TO INSTALLING ROOM FINISHES.
- ALL MASONRY DIMENSIONS ARE NOMINAL DIMENSIONS, MASONRY CONTRACTOR TO ADJUST COURSING AS NEEDED.
- PROPOSED FIRE EXTINGUISHERS ARE LOCATED BY THE SYMBOL ● F.E. COORDINATE TYPE, SIZE AND FINAL LOCATIONS WITH LOCAL FIRE OFFICIALS
- ALL GYP. BRD. WALLS SHALL HAVE LATERAL BRACING AND CONTROL JOINTS AS REQUIRED IN SPECIFICATION SECTIONS 092900.

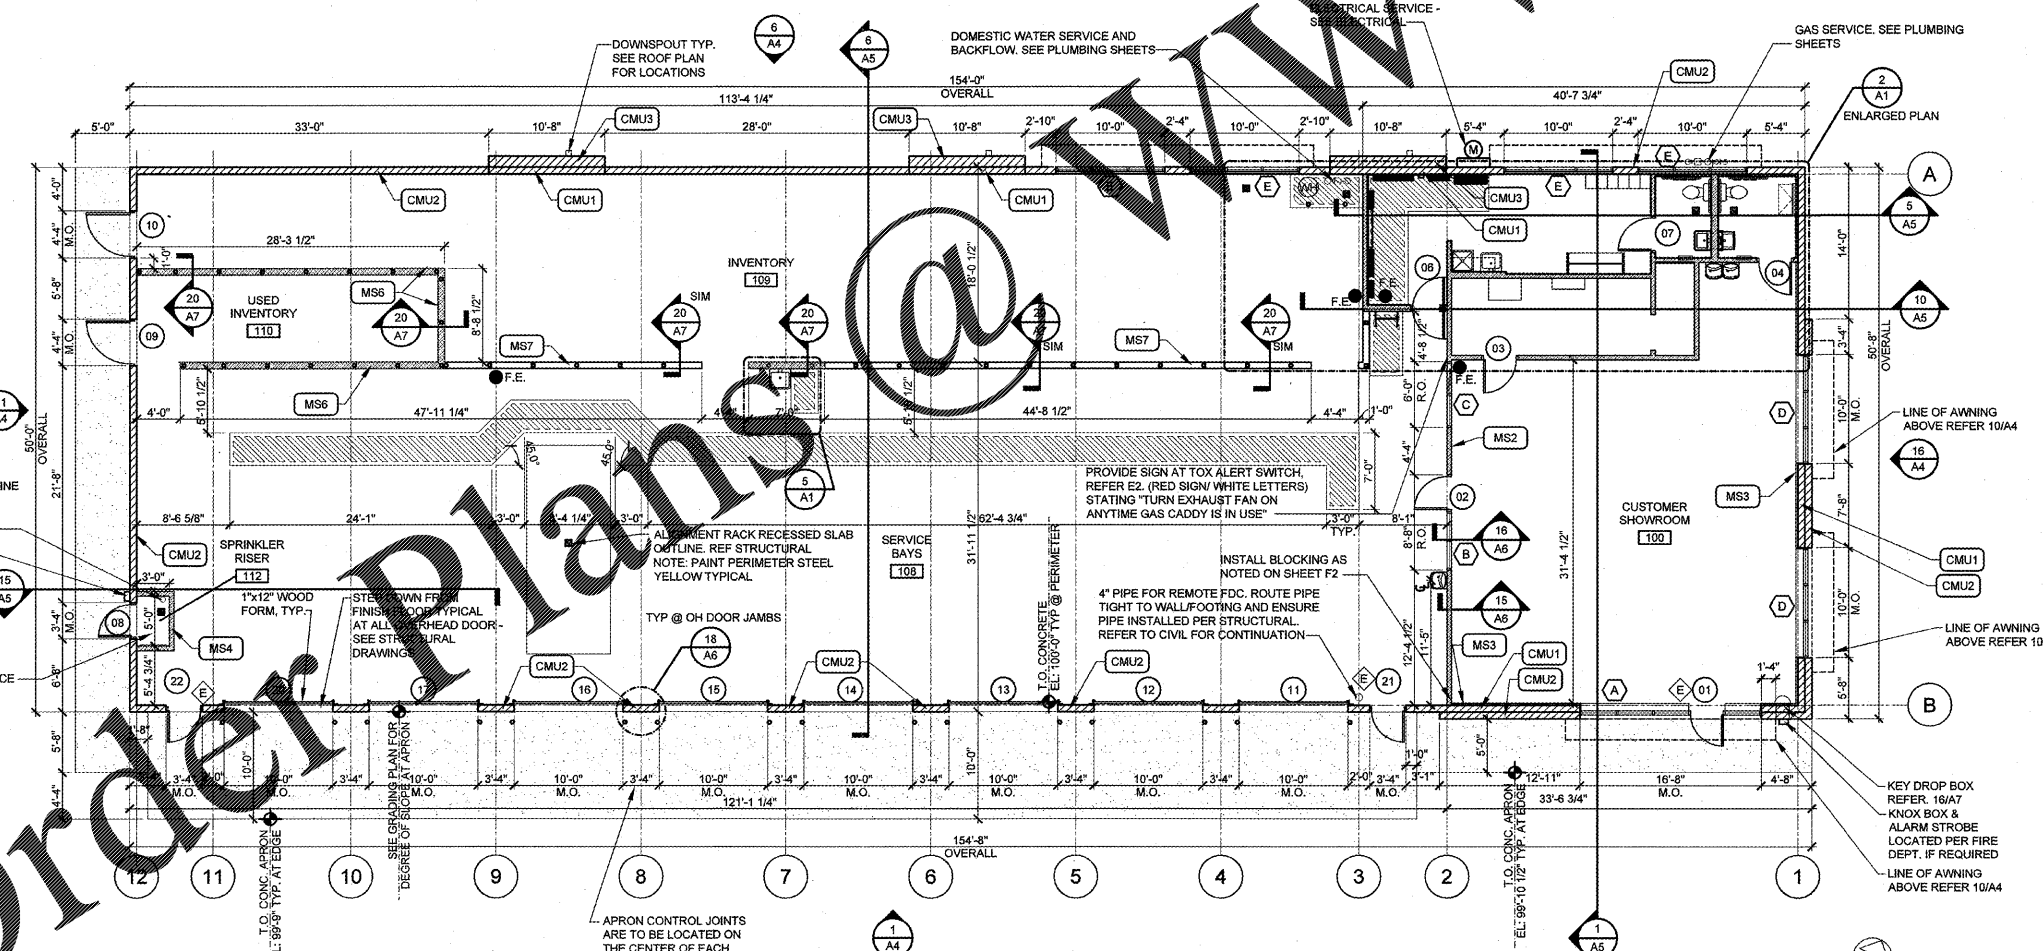

**16 FLOOR PLAN**  
A1 SCALE: 1/8"=1'-0"

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**Firestone COMPLETE AUTO CARE**

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2015 - JUNE - ER - RIGHT  
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WILLIAMSBURG, VA

**DOUG TAYRIEN**  
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**ISSUE BLOCK**

PROPERTY NO.	167739
6 DIGIT NO.	785533
4 DIGIT NO.	8888
AOR PROJECT NUMBER:	1655B14
TO PERMIT:	DATE: 08/10/17
TO BID:	DATE: TBD
DRAWN BY:	JD
CHECKED BY:	MSG

**SHEET TITLE:**  
**FLOOR PLAN AND NOTES**

**SHEET NUMBER:**  
**A1**