

**METAL STUDS FASTENING NOTES**  
 (UNO.)


- METAL STUDS SHALL BE CONNECTED TO STRUCTURAL STEEL w/ (2)  $\emptyset$ 11" x P.D.F.'s
- METAL STUDS SHALL BE CONNECTED TO METAL STUDS / CLIP ANGLES w/ MIN. (4) NO. 12-14 SCREWS
- CONTINUOUS TRACK SHALL BE CONNECTED TO STRUCTURAL STEEL w/ (2)  $\emptyset$ 11" x P.D.F.'s AT 24" O.C.
- CONTINUOUS TRACK / STUDS SHALL BE CONNECTED TO CMU w/ (2) 1/4" x TAPCONS AT 24" O.C.
- CONNECT SHEATHING TO METAL STUDS w/ NO. 12-14 SCREWS AT 6" O.C.
- 1/4 GA. CLIP ANGLES SHALL BE CONNECTED TO CMU w/ (2) 1/4" x TAPCONS

**MTL. STUD WELDING NOTE:**  
 WELD TRUSS w/ 3/32" OR 1/8" AUS TYPE 6013 OR 1014 ROD WITH A WELDING HEAT OF 60-110 AMPERES DEPENDING ON GAGE OF MATERIAL AND FIT.


COORDINATE ALL SOFFIT HEIGHTS AND SECTIONS w/ ARCH

COORDINATE ALL DIMENSIONS WITH ARCHITECTURAL DRAWINGS

SEE ARCH FOR SHEATHING

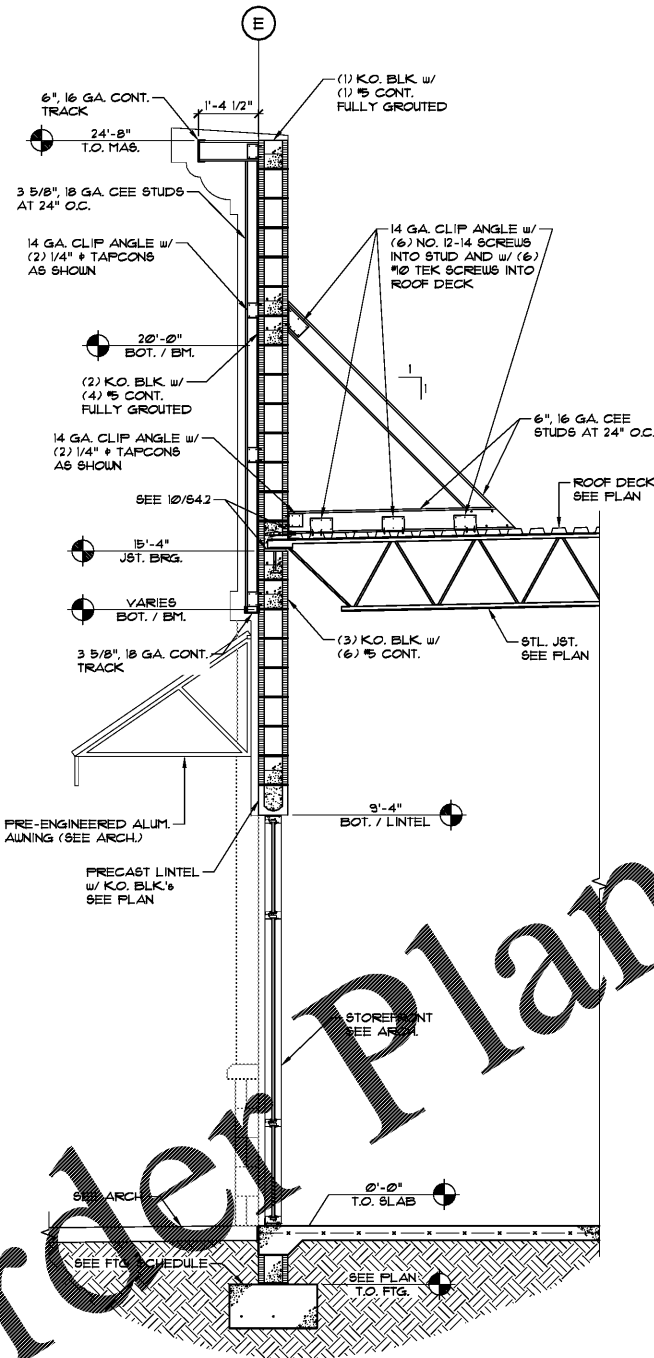

**1 SECTION**  
 533 SCALE: 1/2" = 1'-0"

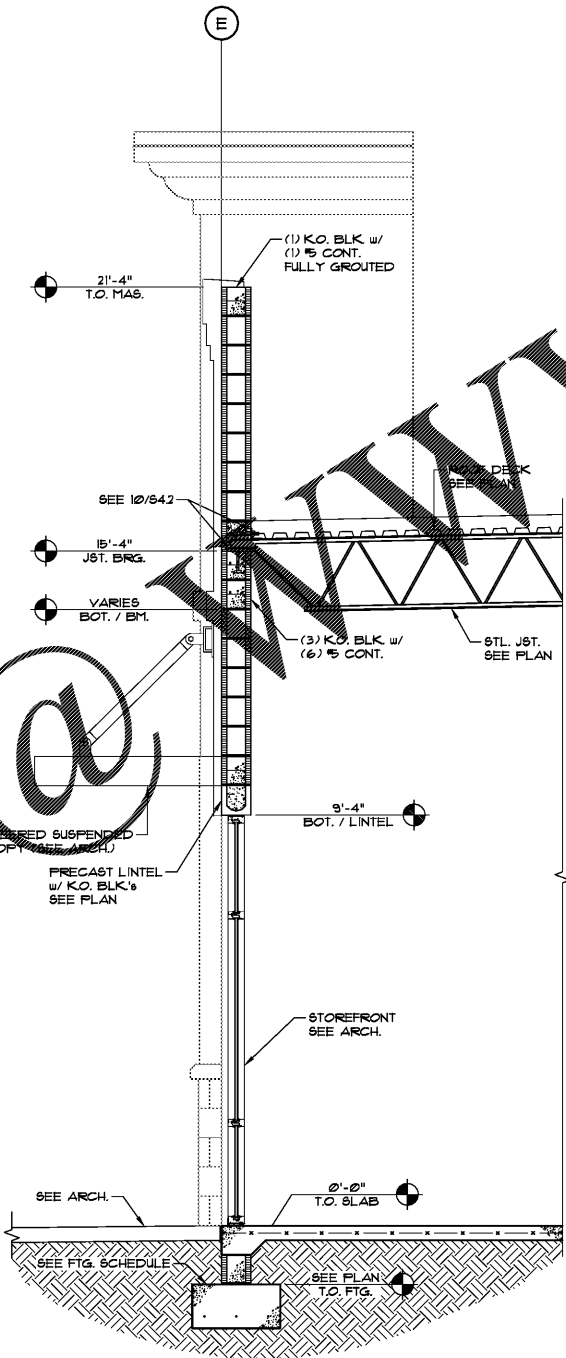

**2 SECTION**  
 533 SCALE: 1/2" = 1'-0"

THE DESIGN PROFESSIONAL DENIES ANY AND ALL RESPONSIBILITY AND LIABILITY FOR PROBLEMS WHICH ARISE FROM FAILURE TO FOLLOW THESE PLANS, SPECIFICATIONS AND THE DESIGN INTENT THEY CONVEY, OR PROBLEMS WHICH ARISE FROM OTHERS FAILURE TO OBTAIN AND/OR FOLLOW THE DESIGN PROFESSIONAL'S GUIDANCE WITH RESPECT TO ANY ERRORS, OMISSIONS, NON-CORRESPONDING AMBIGUITIES OR CONFLICTS WHICH ARE ALLOTTED.

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A NEW DEVELOPMENT FOR:  
**WEST PALM BEACH RETAIL BUILDING**  
 1560 PALM BEACH LAKES BLVD.  
 WEST PALM BEACH, FL 33401

THIS DRAWING HAS BEEN ISSUED:  
 FOR REVIEW ONLY  
 FOR PERMITTING ONLY  
 SCHEMATIC DESIGN  
 DESIGN DEVELOPMENT  
 CONSTRUCTION DOCUMENTS

Drawing Title:  
 WALL SECTIONS

Date: 05/24/17  
 Designed By: JM  
 Drawn By: JM  
 Reviewed By: JM  
 Comm. No. 17-117  
 Revisions: