
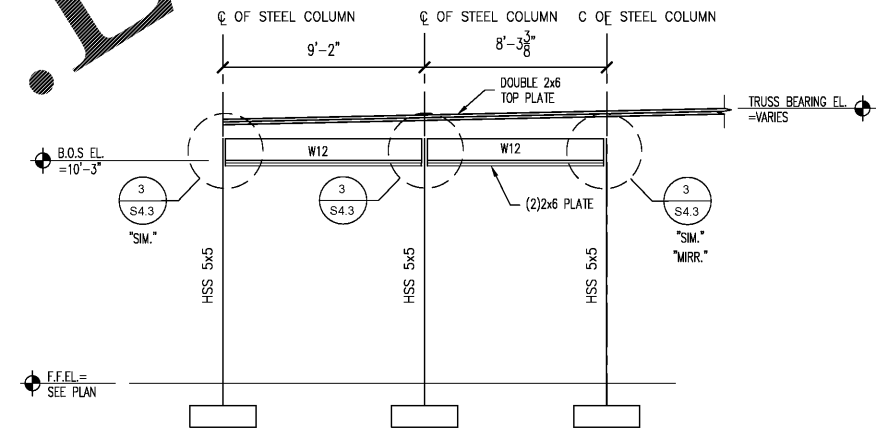
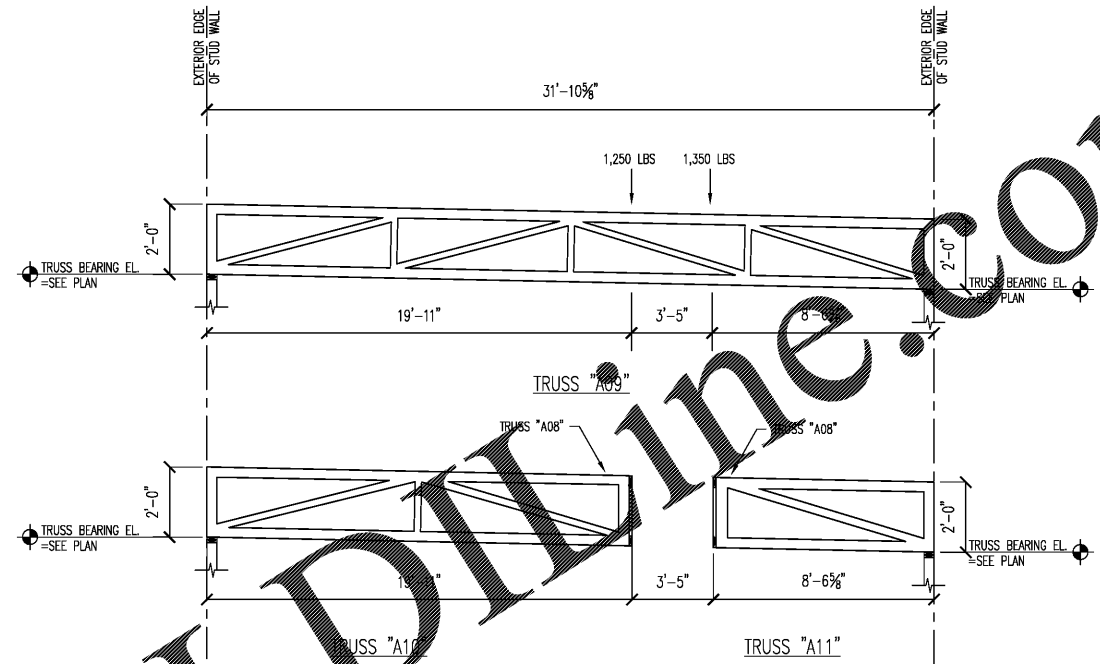
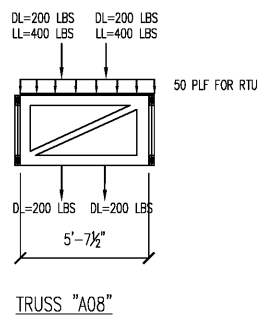
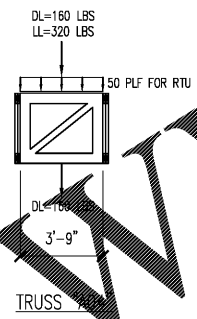


\* TYPICAL LOADS FOR WOOD TRUSS DESIGN


ROOF DEAD	ROOF LIVE	ROOF WIND
10 PSF (TOP CHORD), 10 PSF (BOTTOM CHORD)	20 PSF	+10 PSF, -20 PSF

WIND SPEED = 115 MPH (2012 IBC FIGURE 1609A)

\* SEE A ROOF FRAMING PLAN S2.2 FOR ROOF SLOPE

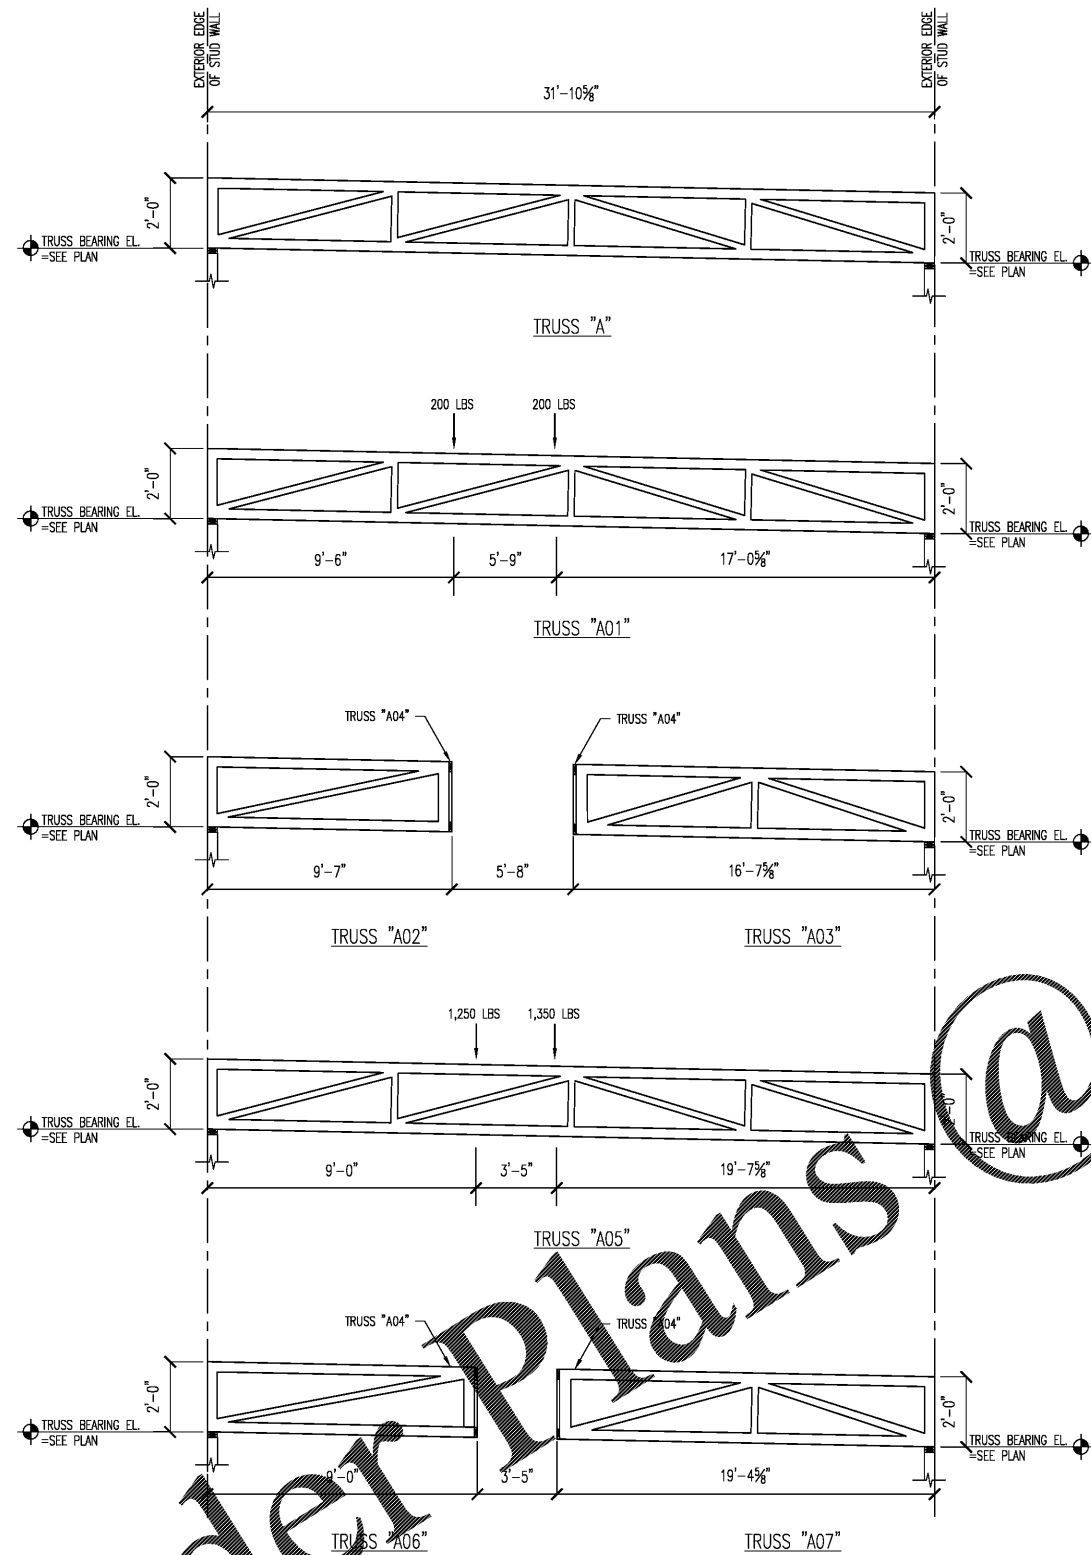


1 MOMENT FRAMING ELEVATION  
SCALE: 3/4" = 1'-0"

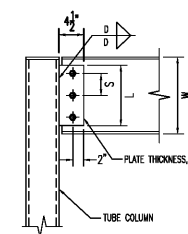

W	L	S	T	D	NO. BOLTS	BOLT #
12	10	3	X	3/8	3	3/4"

UNIT: INCH

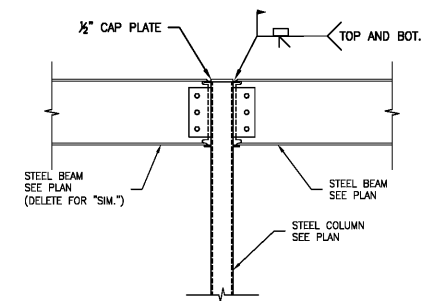

2 BEAM TO COLUMN CONNECTION  
SCALE: 3/4" = 1'-0"


3 SECTION  
SCALE: 3/4" = 1'-0"

Order Plans @

NO.	DATE	DESCRIPTION

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DUNKIN' DONUTS  
for  
SHULER DEVELOPMENT  
STORE #357147  
4880-4890 PORT ROYAL ROAD  
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DRAWN BY: BJ  
CHECKED BY: KK  
DATE: 09/28/17  
SCALE: AS NOTED  
C.A. COMMISSION NUMBER: 1704

FRAMING SECTIONS & DETAILS

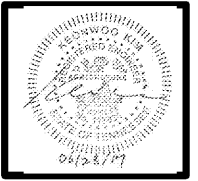S4.3