


Order Plans @

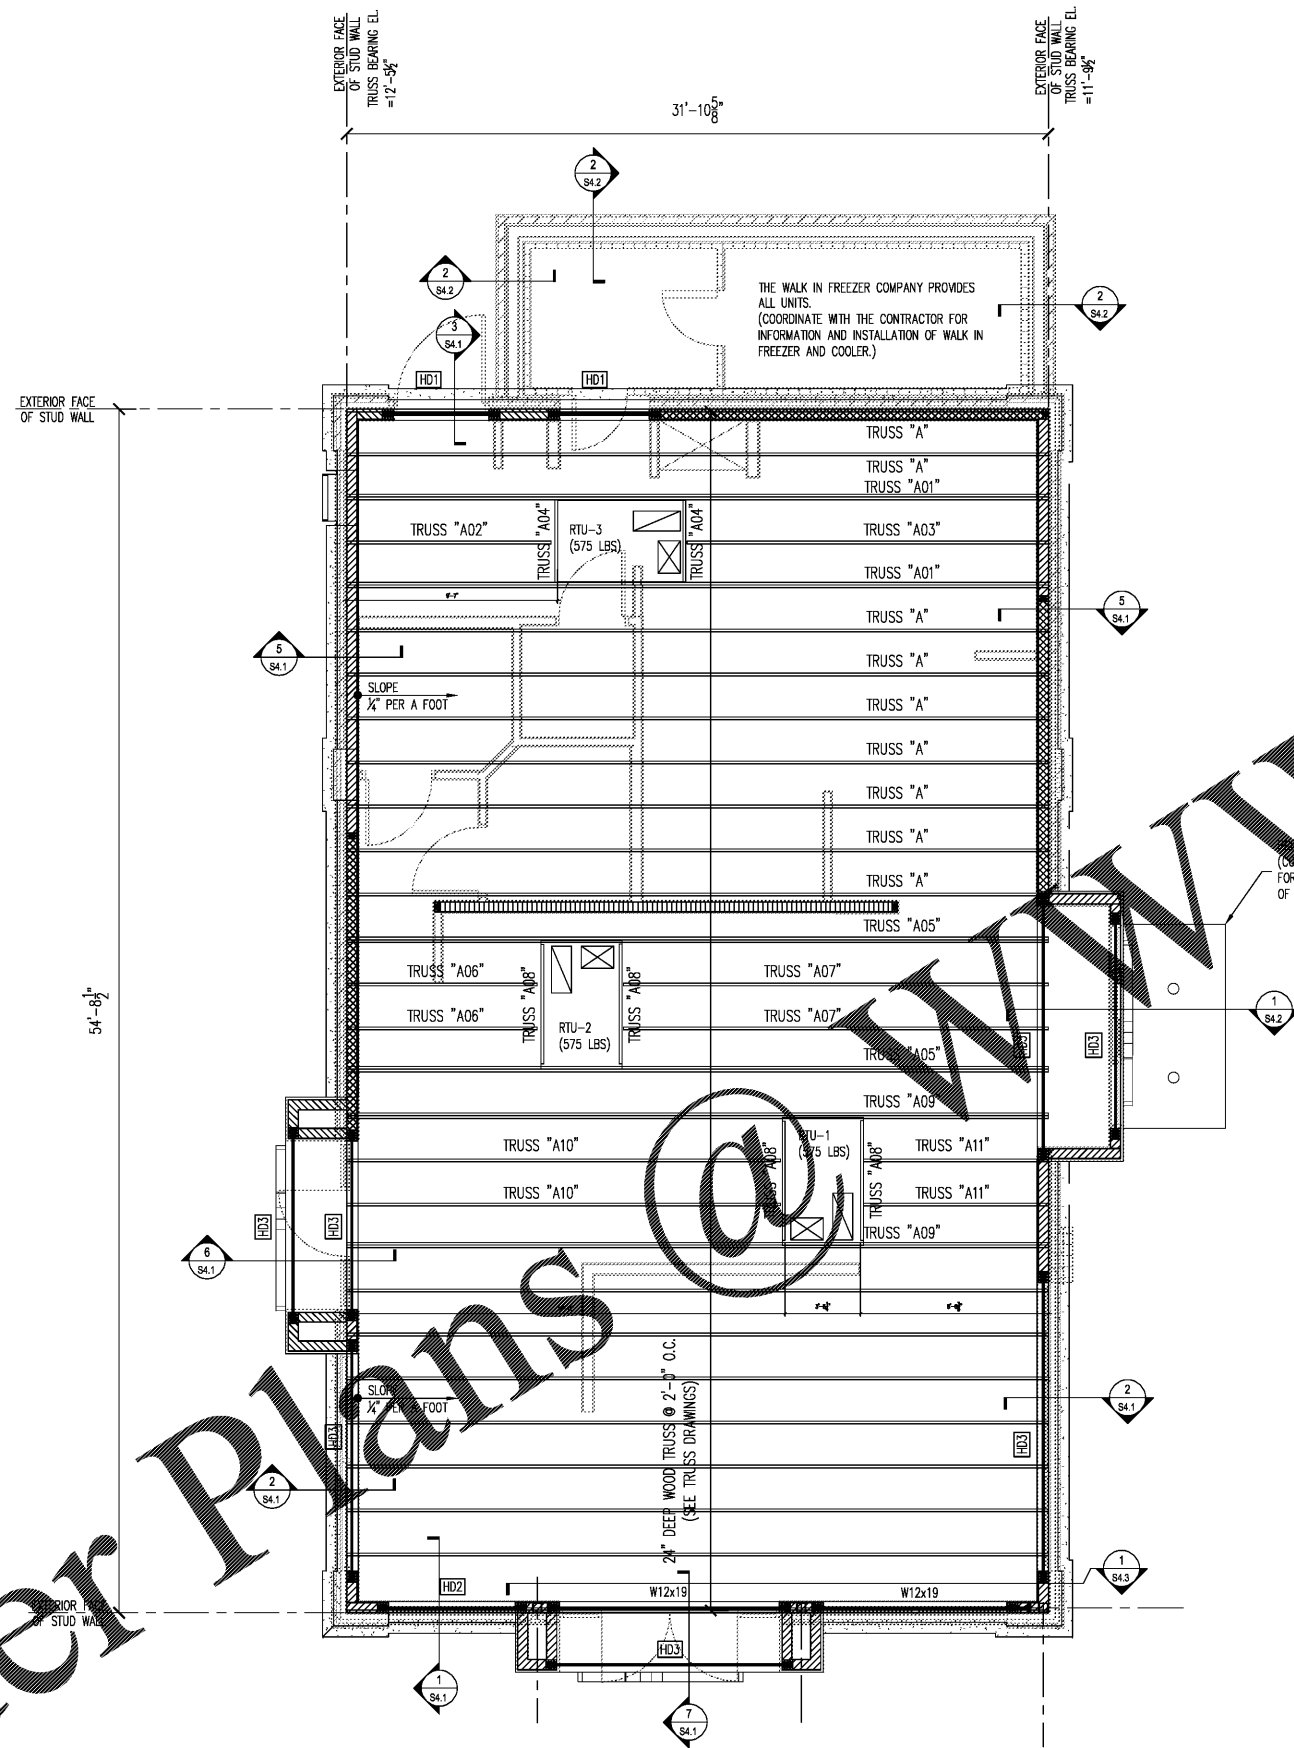

ROOF FRAMING PLAN NOTES:



1. ROOF SHEATHINGS SHALL BE MIN. 5/8" THICK APA RATED OSB SHEATHING WITH 10d NAILS @ 6" O.C. AT DIAPHRAGM BOUNDARY, @ 6" O.C. AT ALL PANEL EDGE OF ROOF SHEATHINGS, @ 12" O.C. AT INTERMEDIATE SUPPORT. ALL ROOF SHEATHINGS SHALL BE CONNECTED TO ADJACENT SHEATHING WITH 1" x 4" @ 16" O.C. PROVIDE A BLOCKING AT ALL PANEL EDGE OF ROOF SHEATHINGS.
2. SEE PLAN FOR TRUSS BEARING ELEVATIONS. STRUCTURE SLOPE UNIFORMLY BETWEEN POINTS OF GIVEN ELEVATIONS.
3. ANY LOAD SUSPENDED FROM THE ROOF STRUCTURAL SHALL HANG DIRECTLY FROM THE TRUSS. OTHERWISE, PROVIDE ADDITIONAL SUPPORT MATERIAL, DESIGNED TO CARRY THE LOAD BETWEEN THE STRUCTURAL MEMBER.
4. SEE ARCHITECTURAL AND MECHANICAL DRAWINGS FOR EXACT SIZE AND LOCATIONS OF ROOF UNITS, AND ANY OPENINGS.

ROOF FRAMING PLAN LEGEND:

- E.B.E.L. INDICATES TRUSS BEARING ELEVATION.
- HD1 INDICATES HEADER MARK. SEE HEADER SCHEDULE.
- INDICATES 6" LOAD BEARING SHEAR WALL BELOW.
- INDICATES 6" LOAD BEARING WALL BELOW.
- INDICATES 6" NON LOAD BEARING SHEAR WALL BELOW.

HEADER SCHEDULE

MARK	HEADER SIZE	DETAIL	MIN. SUPPORT	NOTES
HD 1	(3) 2x6 W/ (2) 1/2" PLYWOOD	DETAIL 1 /S2.2	(2) JACK & (2) KING	
HD 2	(3) 2x8 W/ (2) 1/2" PLYWOOD	DETAIL 1 /S2.2	(2) JACK & (2) KING	
HD 3	(3) 1.75 x 9.25 LVL W/ (1) 1/4" PLYWOOD	DETAIL 2 /S2.2	(2) JACK & (2) KING	

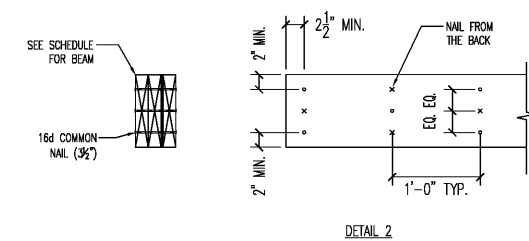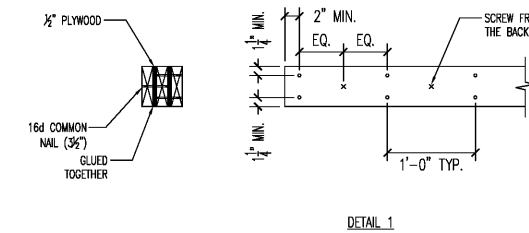

ROOF FRAMING PLAN


SCALE: 1/4" = 1'-0"

RELEASED FOR CONSTRUCTION

NO.	DATE	DESCRIPTION

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DRAWN BY: BJ
CHECKED BY: KK
DATE: 09/28/17
SCALE: AS NOTED
C.A. COMMISSION NUMBER: 1704

ROOF FRAMING PLAN

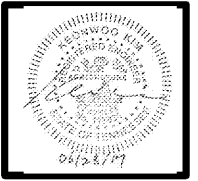S2.2